

Received
Planning Division
04/11/2024



Todd Prager & Associates LLC

MEMORANDUM

DATE: December 10, 2023
TO: Kim-Hien Nguyen
FROM: Todd Prager, RCA #597, ISA Board Certified Master Arborist
RE: Tree Protection Plan for 4975 SW 139th Avenue

Summary

This is the tree protection plan for the proposed lot partition and construction at 4975 SW 139th Avenue in Beaverton, Oregon. Both onsite trees are proposed for removal and all 11 offsite trees near the property line will be retained and protected according to the recommendations in this report.

Background

Kim-Hien Nguyen is proposing to partition her property at 4975 SW 139th Avenue in Beaverton and construct a duplex on the new rear parcel 2. On November 14, 2023, I inventoried and assessed the two existing onsite trees along with 11 offsite trees near the property. The tree inventory is in Attachment 1 and the proposed site plans with tree locations are in Attachment 2. The tree numbers on plan sheet 8 of 9 in Attachment 2 correspond to the tree numbers in the tree inventory in Attachment 1.

Based on the proposed construction shown in Attachment 2, both onsite trees are proposed for removal. All 11 offsite trees will be retained and protected according to the recommendations in this report. The purpose of this report is to provide protection recommendations for the trees to be retained.

Tree Protection Recommendations

The standard tree protection requirement in the City of Beaverton Code is to protect trees at five feet beyond the driplines.

A typical alternative minimum protection zone allows encroachments no closer than a radius from a tree of 0.5 feet per inch of DBH if no more than 25 percent of the root protection zone area (estimated at one foot radius per inch of DBH) is impacted. Figure 1 illustrates this concept.

The reason for using this alternative is because it allows the tree protection zone to better relate to the size of the tree and its root zone. Tree driplines can be highly variable based on species growth habits and onsite conditions such as the presence of adjacent trees or past pruning.

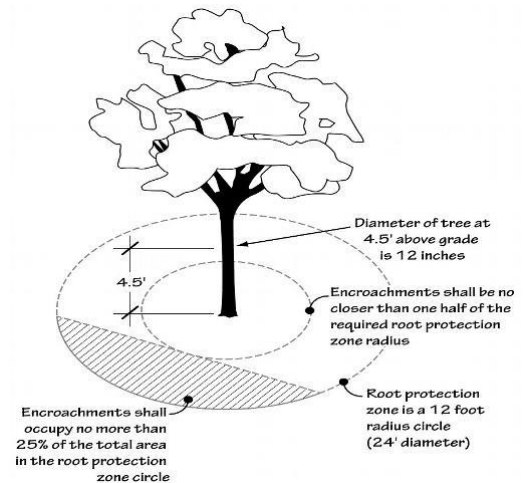


Figure 1: Typical minimum protection zone

The tree protection zones shown on the plan sheets in Attachment 2 will protect the minimum protection zones shown in Figure 1 for the trees to be retained prior to construction with arborist oversight to minimize impacts when construction is required within those zones. The following site-specific recommendations will help to minimize construction impacts for the trees to be retained:

Tree Protection Fencing:

Prior to construction, tree protection fencing shall be set in the locations shown on the plan sheets in Attachment 2. When work is required within the tree protection zones, it shall be under the onsite supervision of the project arborist.

Arborist Oversight:

The project arborist shall be onsite to oversee, guide, and document driveway paving and construction of the retaining wall for the stormwater facility within the tree protection zones adjacent to trees 3 through 13. Work within the zones will be documented for the owner by the project arborist.

Paving:

The driveway access adjacent to trees 3 through 8 along the north property line shall be constructed of clean crushed rock (with no fines) over geotextile fabric that is permeable to air and water. The surface litter layer shall be carefully removed under arborist supervision prior to fabric and rock placement to minimize damage and disturbance to any surface roots of trees to be retained. No excavation beyond the native soil surface is permitted. At least four inches of crushed rock over geotextile fabric shall be placed over exposed surface roots to protect them from damage. The paving detail on sheet 4 of 9 in Attachment 2 includes the required paving cross section in the tree protection zone.

Pruning:

It may be necessary or desirable to prune trees that overhang the site. All pruning should be completed by a qualified tree service with an ISA Certified Arborist on site. All pruning should be in accordance with ANSI A300 pruning standards and Z133.1 safety standards and approved in coordination with the project arborist.

Sediment Fencing:

Sediment fencing shall be installed outside the protection zones of the trees to be retained to minimize root disturbances. If erosion control is required inside the protection zones, straw wattles shall be used on the soil surface.


The following additional tree protection recommendations meet and/or exceed Beaverton Development Code requirements:

Before Construction Begins

1. Notify all contractors of tree protection procedures. For successful tree protection on a construction site, all contractors must know and understand the goals of tree protection.
 - a. Hold a tree protection meeting with all contractors to explain the goals of tree protection.
 - c. Have all contractors sign memoranda of understanding regarding the goals of tree protection. The memoranda should include a penalty for violating the tree protection plan. The penalty should equal the resulting fines issued by the local jurisdiction or the appraised value of the tree(s) within the violated tree protection zone per the current Trunk Formula Technique as outline in the current edition of the ***Guide for Plant Appraisal*** by the Council of Tree & Landscape Appraisers, whichever is greater. The penalty should be paid to the owner of the property.
2. Fencing
 - a. Trees to remain on site will be protected by installation of tree protection fencing at the edge of the protected root zone, which is defined by the City of Beaverton as the tree dripline plus 5-feet. Alternatively, tree protection fencing may be set as shown on the plan sheets in Attachment 2.
 - b. The fencing should be put in place before the ground is cleared to protect the trees and the soil around the trees from disturbances.
 - c. Fencing should be established by the project arborist based on the needs of the trees to be protected and to facilitate construction.
 - d. Fencing should consist of 6-foot high steel fencing on concrete blocks or 6-foot metal fencing secured to the ground with 8-foot metal posts to prevent it from being moved by contractors, sagging, or falling down. Alternative fencing material that meets the City of Beaverton tree protection requirements may also be used.
 - e. Fencing should remain in the position that is established by the project arborist and not be moved without approval from the project arborist until final project approval.

3. Signage

- a. All tree protection fencing should have signage as follows so that all contractors understand the purpose of the fencing:

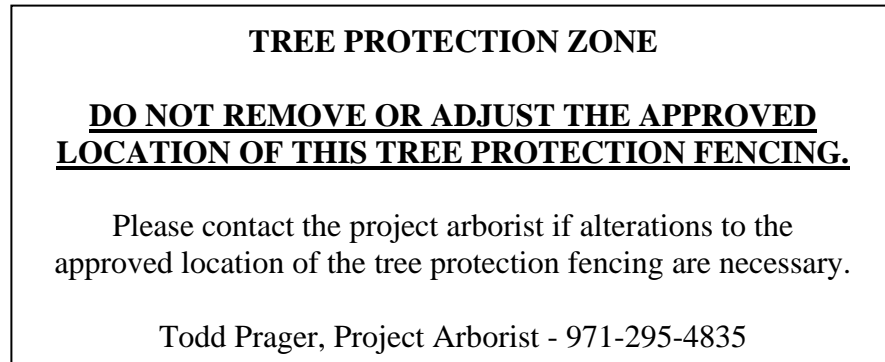

- b. Signage should be placed every 75-feet or less.
- c. Colored tree flagging indicating that this area is a tree protection zone is to be placed every five (5) linear feet on the fence to alert construction crews of the sensitive nature of the area.

During Construction

1. Protection Guidelines Within the Tree Protection Zones:
- a. No new buildings; grade change or cut and fill, during or after construction; new impervious surfaces; or utility or drainage field placement should be allowed within the tree protection zones.
 - b. No traffic should be allowed within the tree protection zones. This includes but is not limited to vehicle, heavy equipment, or even repeated foot traffic.
 - c. No storage of materials including but not limiting to soil, construction material, or waste from the site should be permitted within the tree protection zones. Waste includes but is not limited to concrete wash out, gasoline, diesel, paint, cleaner, thinners, etc.
 - d. Construction trailers should not be parked/placed within the tree protection zones.
 - e. No vehicles should be allowed to park within the tree protection zones.
 - f. No other activities should be allowed that will cause soil compaction within the tree protection zones.
2. The trees should be protected from any cutting, skinning or breaking of branches, trunks or woody roots.
3. The project arborist should be notified prior to the cutting of woody roots from trees that are to be retained to evaluate and oversee the proper cutting of roots with sharp cutting tools. Cut roots should be immediately covered with soil or mulch to prevent them from drying out.
4. Trees that have roots cut should be provided supplemental water during the summer months.
5. Any necessary passage of utilities through the tree protection zones should be by means of tunneling under woody roots by hand digging or boring with oversight by the project arborist.

6. Any deviation from the recommendations in this section should receive prior approval from the project arborist.

After Construction

1. Carefully landscape the areas within the tree protection zones. Do not allow trenching for irrigation or other utilities within the tree protection zones.
2. Carefully plant new plants within the tree protection zones. Avoid cutting the woody roots of trees that are retained.
3. Do not install permanent irrigation within the tree protection zones unless it is drip irrigation to support a specific planting or the irrigation is approved by the project arborist.
4. Provide adequate drainage within the tree protection zones and do not alter soil hydrology significantly from existing conditions for the trees to be retained.
5. Provide for the ongoing inspection and treatment of insect and disease populations that can damage the retained trees and plants.
6. The retained trees may need to be fertilized if recommended by the project arborist.
7. Any deviation from the recommendations in this section should receive prior approval from the project arborist.

If adhering to any of the tree protection recommendations in this section of the report is not feasible, additional trees may need to be removed.

Conclusion

The recommendations in this report will provide adequate protection for the offsite trees to be retained.

Please contact me if you have questions, concerns, or need additional information.

Sincerely,



Todd Prager

*ASCA Registered Consulting Arborist #597
ISA Board Certified Master Arborist, WE-6723B
ISA Qualified Tree Risk Assessor
AICP, American Planning Association*

Attachment: Attachment 1: Tree Inventory
Attachment 2: Plan Sheets with Tree Protection
Attachment 3: Assumptions and Limiting Conditions



Todd Prager & Associates
LLC

Attachment 1

Tree No.	Common Name	Scientific Name	Decid. or Conif.	DBH ¹	C-Rad ²	Condition ³	Structure ³	Comments	Tree Type	Treatment
1	orchard apple	<i>Malus domestica</i>	decid.	15	13	fair	fair	headed for fruit production	exempt ⁴ (edible fruit tree)	remove
2	western redcedar	<i>Thuja plicata</i>	conif.	10	11	very poor	very poor	dying from top down	community tree	remove
3	incense cedar	<i>Calocedrus decurrens</i>	conif.	12,12	10	fair	fair	headed, offsite, size and location approximated by arborist	offsite	retain
4	incense cedar	<i>Calocedrus decurrens</i>	conif.	7	5	good	fair	moderately one sided, offsite, size and location approximated by arborist	offsite	retain
5	incense cedar	<i>Calocedrus decurrens</i>	conif.	7	4	good	good	offsite, size and location approximated by arborist	offsite	retain
6	incense cedar	<i>Calocedrus decurrens</i>	conif.	14	8	fair	fair	headed, one sided, offsite, size and location approximated by arborist	offsite	retain
7	incense cedar	<i>Calocedrus decurrens</i>	conif.	8	6	good	fair	multiple leaders at top, offsite, size and location approximated by arborist	offsite	retain
8	incense cedar	<i>Calocedrus decurrens</i>	conif.	12	4	fair	fair	headed, one sided, offsite, size and location approximated by arborist	offsite	retain
9	incense cedar	<i>Calocedrus decurrens</i>	conif.	14	10	good	fair	codominant at 8', one sided, offsite, size and location approximated by arborist	offsite	retain
10	incense cedar	<i>Calocedrus decurrens</i>	conif.	14	10	good	fair	codominant at 8', one sided, offsite, size and location approximated by arborist	offsite	retain
11	river birch	<i>Betula nigra</i>	decid.	12	20	good	fair	multiple leaders at 10' to 15', offsite, size and location approximated by arborist	offsite	retain
12	river birch	<i>Betula nigra</i>	decid.	13	15	good	fair	multiple leaders at 10' to 15', offsite, size and location approximated by arborist	offsite	retain
13	English hawthorn	<i>Crataegus monogyna</i>	decid.	7,4,3x8	8	good	fair	multiple leaders at ground level, offsite, size and location approximated by arborist	offsite	retain


¹DBH is the trunk diameter measured according to the International Society of Arboriculture standards in inches. In cases where the tree splits into multiple trunks at ground level, DBH is the square root of the sum of the squared DBH of each stem.

²C-rad is the approximate crown radius in feet.

³Condition and Structure ratings range from very poor, poor, fair, to good.

⁴Exempt trees include hemlock, madrone, and bigleaf maples less than 6-inch DBH, any other species less than 10-inch DBH, trees listed a nuisance species on the Metro Native Plant List (Ord. No. 98-730C) or Beaverton Development Code Section 40.90.10, trees producing edible fruits, offsite trees, and stumps. Note that although hemlock, madrone, and bigleaf maples between 6- and 10-inch DBH are surveyed trees, they are not considered community trees and thus are "exempt".

Tree protection fence to be installed prior to construction with work in tree protection zone to be overseen by project arborist

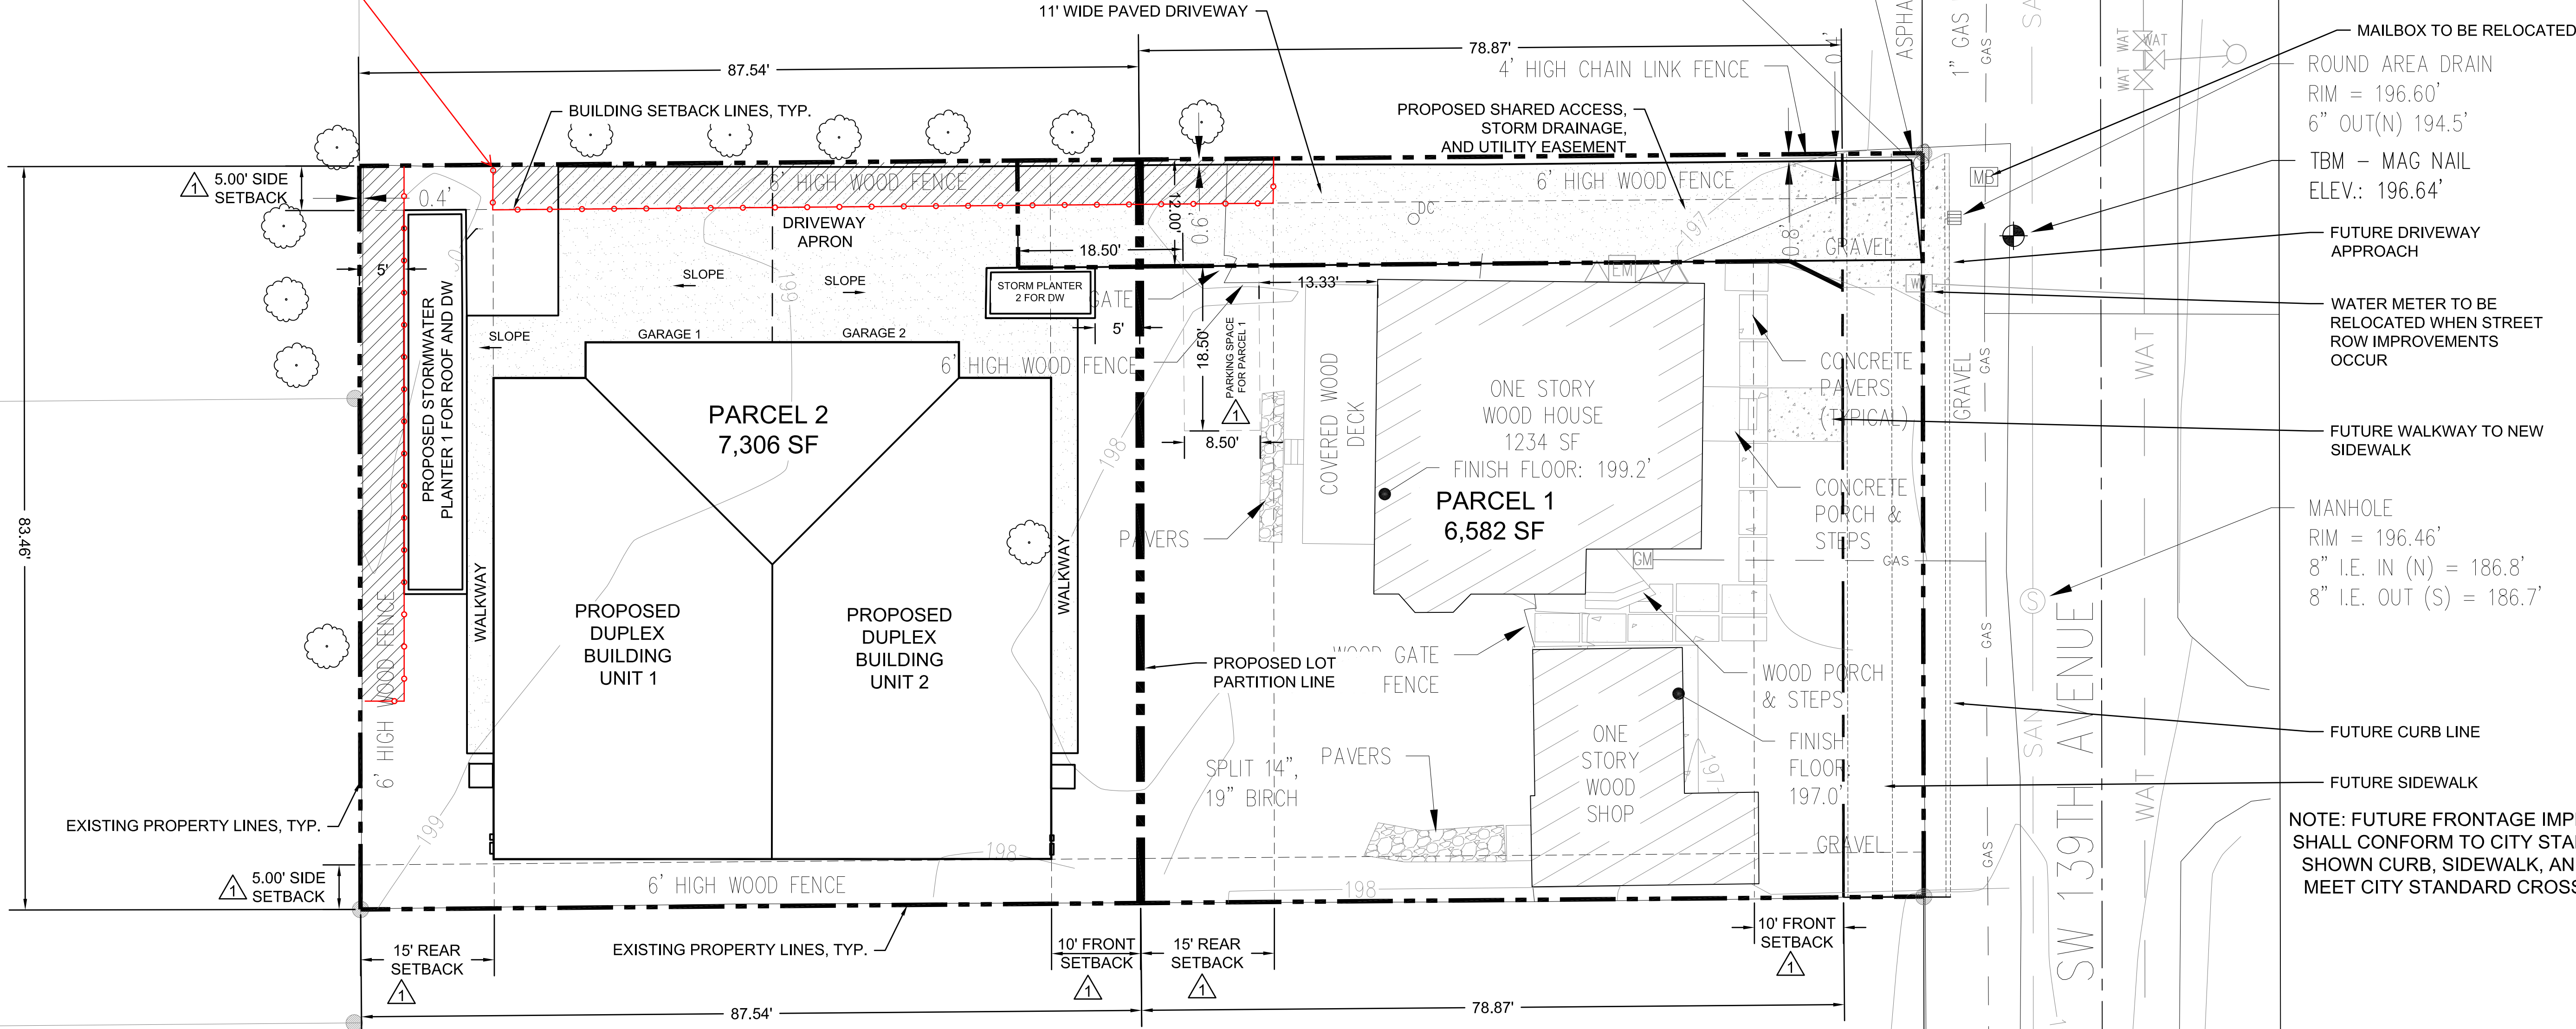



MAILBOX TO BE RELOCATED
 ROUND AREA DRAIN
 RIM = 196.60'
 6" OUT(N) 194.5'
 TBM - MAG NAIL
 ELEV.: 196.64'
 FUTURE DRIVEWAY APPROACH
 WATER METER TO BE RELOCATED WHEN STREET ROW IMPROVEMENTS OCCUR
 FUTURE WALKWAY TO NEW SIDEWALK
 MANHOLE
 RIM = 196.46'
 8" I.E. IN (N) = 186.8'
 8" I.E. OUT (S) = 186.7'
 FUTURE CURB LINE
 FUTURE SIDEWALK
 NOTE: FUTURE FRONTAGE IMPROVEMENTS SHALL CONFORM TO CITY STANDARDS (AS SHOWN CURB, SIDEWALK, AND PLANTER MEET CITY STANDARD CROSS SECTION)

PROPOSED SITE NOTES:



1. SETBACKS PER SHEET A.00-2
2. GRADE DRIVEWAY AS SHOWN TO FLOW TO STORMWATER PLANTERS
3. STORMWATER PLANTERS SIZED PER CWS LIDA HANDBOOK WITH A 0.06 SIZING FACTOR
 - 3.1. STORMWATER PLANTER 1 DRAINAGE AREA: ROOF = 3,547 SF, DRIVEWAY/WALKWAYS = 684 SF
 - 3.1.1. PLANTER SIZE = 0.06 X (3547 + 684) = 254 SF
 - 3.2. STORMWATER PLANTER 2 DRAINAGE AREA = DRIVEWAY/WALKWAYS = 877 SF
 - 3.2.1. PLANTER SIZE = 0.06 X 877 = 53 SF
4. STORMPLANTERS TO BE A MINIMUM OF 5' FROM PROPERTY LINES.
5. A GEOTECHNICAL REPORT SHALL BE COMPLETED PRIOR BUILDING PERMIT DESIGN TO DETERMINE IF THE STORMWATER PLANTER IS AN INFILTRATION OR STRUCTURAL PLANTER.
6. ALL OTHER SLOPES AND GRADES SHALL MEET BUILDING CODE DESIGN.



PROPOSED SITE PLAN
 SCALE: 1"=10'

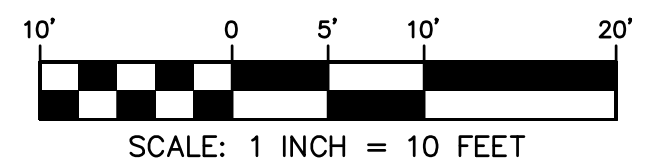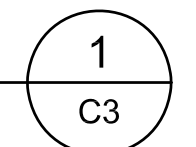

Attachment 2

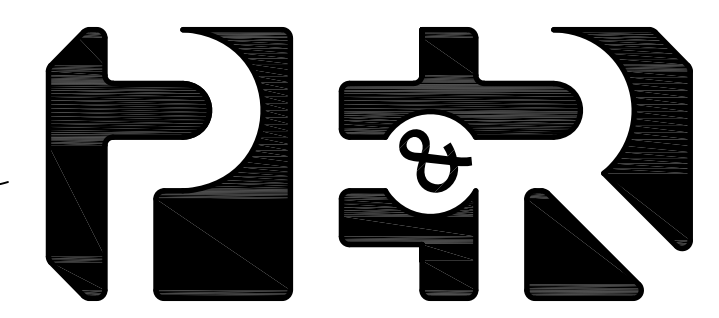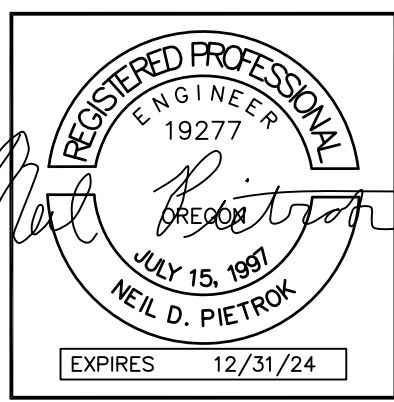

PIETROK ENGINEERING AND RESOURCES LLC
 13539 NW Springville Road
 Portland, OR 97229
 PH: 503-793-3469

FILENAME	178-C3
DATE	06/06/2023
DESIGNER	NDP
DRAFTER	NDP
REVIEWER	DI

TWO LOT PARTITION FOR
 TL ID: 1S116CA03000
 4975 SW 139TH AVENUE
 BEAVERTON, OREGON 97005
 R129462
 ZONING: SFR, RMC


SW 139TH AVENUE

BEAVERTON, OR

LOT PARTITION
 PROPOSED SITE PLAN

No.	REVISION	DATE	BY
1		12/8/23	NDP

SHEET 3 OF 9
 DRAWING NUMBER 178-C3

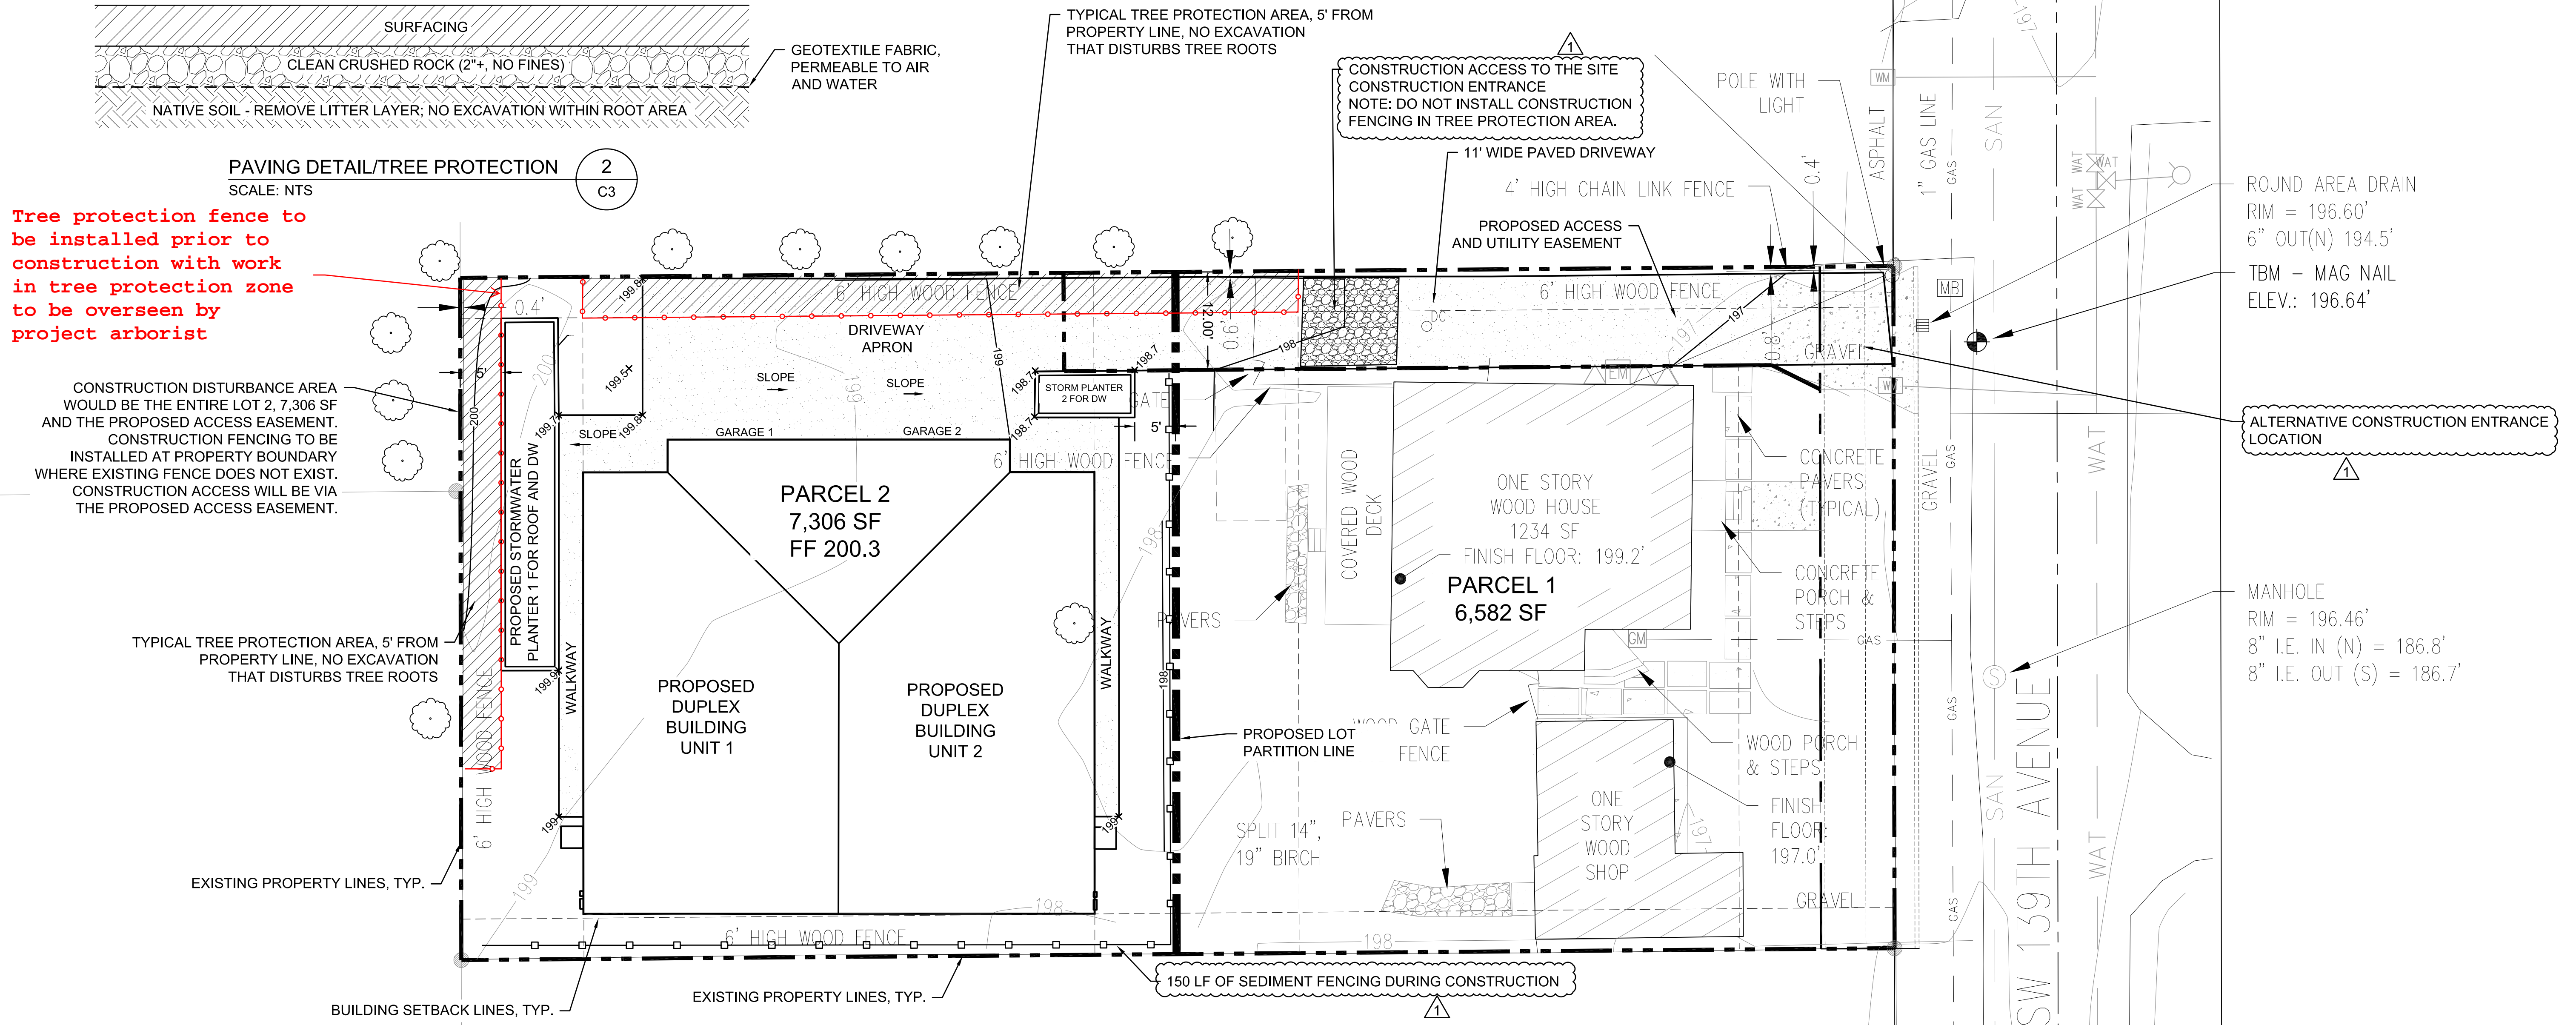

PAVING DETAIL/TREE PROTECTION (2)
 SCALE: NTS
 C3

Tree protection fence to be installed prior to construction with work in tree protection zone to be overseen by project arborist

CONSTRUCTION DISTURBANCE AREA WOULD BE THE ENTIRE LOT 2, 7,306 SF AND THE PROPOSED ACCESS EASEMENT. CONSTRUCTION FENCING TO BE INSTALLED AT PROPERTY BOUNDARY WHERE EXISTING FENCE DOES NOT EXIST. CONSTRUCTION ACCESS WILL BE VIA THE PROPOSED ACCESS EASEMENT.

TYPICAL TREE PROTECTION AREA, 5' FROM PROPERTY LINE, NO EXCAVATION THAT DISTURBS TREE ROOTS

EXISTING PROPERTY LINES, TYP.

BUILDING SETBACK LINES, TYP.

PROPOSED GRADING NOTES:

1. SETBACKS PER SHEET A.00-2
2. GRADE DRIVEWAY AS SHOWN TO FLOW TO STORMWATER PLANTERS
3. ALL OTHER SLOPES AND GRADES SHALL MEET BUILDING CODE DESIGN.
4. THE NEW STRUCTURE PROPOSED WILL BE AT GRADE. NO SIGNIFICANT GRADING OR CROSS SECTION WILL BE NEEDED FOR THIS SITE OTHER THAN FINE GRADING FOR THE NEW DRIVEWAY.


ADDITIONAL CONSTRUCTION NOTES:

1. THE SITE IS SURROUNDING ON THREE SIDES BY FENCE, NO CONSTRUCTION FENCE IS PROPOSED ON THESE SIDES OF THE PROPERTY.
2. PLACE CONSTRUCTION FENCING ON THE BOUNDARY OF THE NEW LOT LINE EXCEPT THE ENTRY.



PROPOSED SITE PLAN
 SCALE: 1"=10'

(1)
 C3


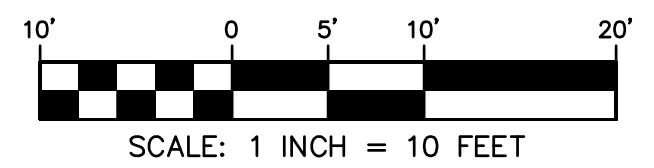


ROUND AREA DRAIN
 RIM = 196.60'
 6" OUT(N) 194.5'
 TBM - MAG NAIL
 ELEV.: 196.64'

ALTERNATIVE CONSTRUCTION ENTRANCE LOCATION

MANHOLE
 RIM = 196.46'
 8" I.E. IN (N) = 186.8'
 8" I.E. OUT (S) = 186.7'

Attachment 2

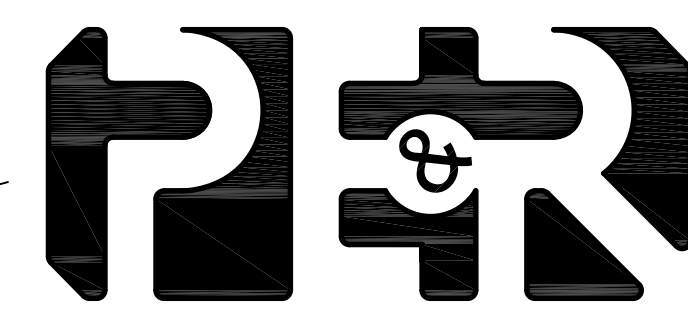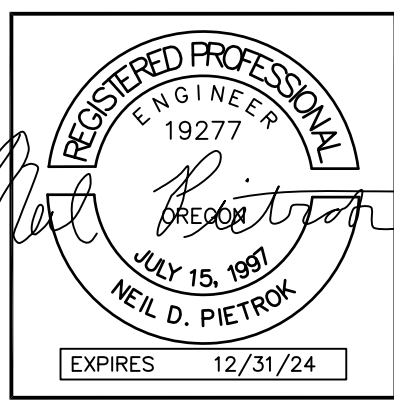

PIETROK ENGINEERING AND RESOURCES LLC
 13539 NW Springville Road
 Portland, OR 97229
 PH: 503-793-3469

FILENAME	178-C4
DATE	06/06/2023
DESIGNER	NDP
DRAFTER	NDP
REVIEWER	DI

TWO LOT PARTITION FOR
 TL ID: 1S116CA03000
 4975 SW 139TH AVENUE
 BEAVERTON, OREGON 97005
 R129462
 ZONING: SFR, RMC

SW 139TH AVENUE


BEAVERTON, OR

LOT PARTITION
 GRADING PLAN

No.	REVISION	DATE	BY
1	REVISION	12/8/23	NDP

SHEET 4 OF 9
 DRAWING NUMBER 178-C4

Tree protection fence to be installed prior to construction with work in tree protection zone to be overseen by project arborist

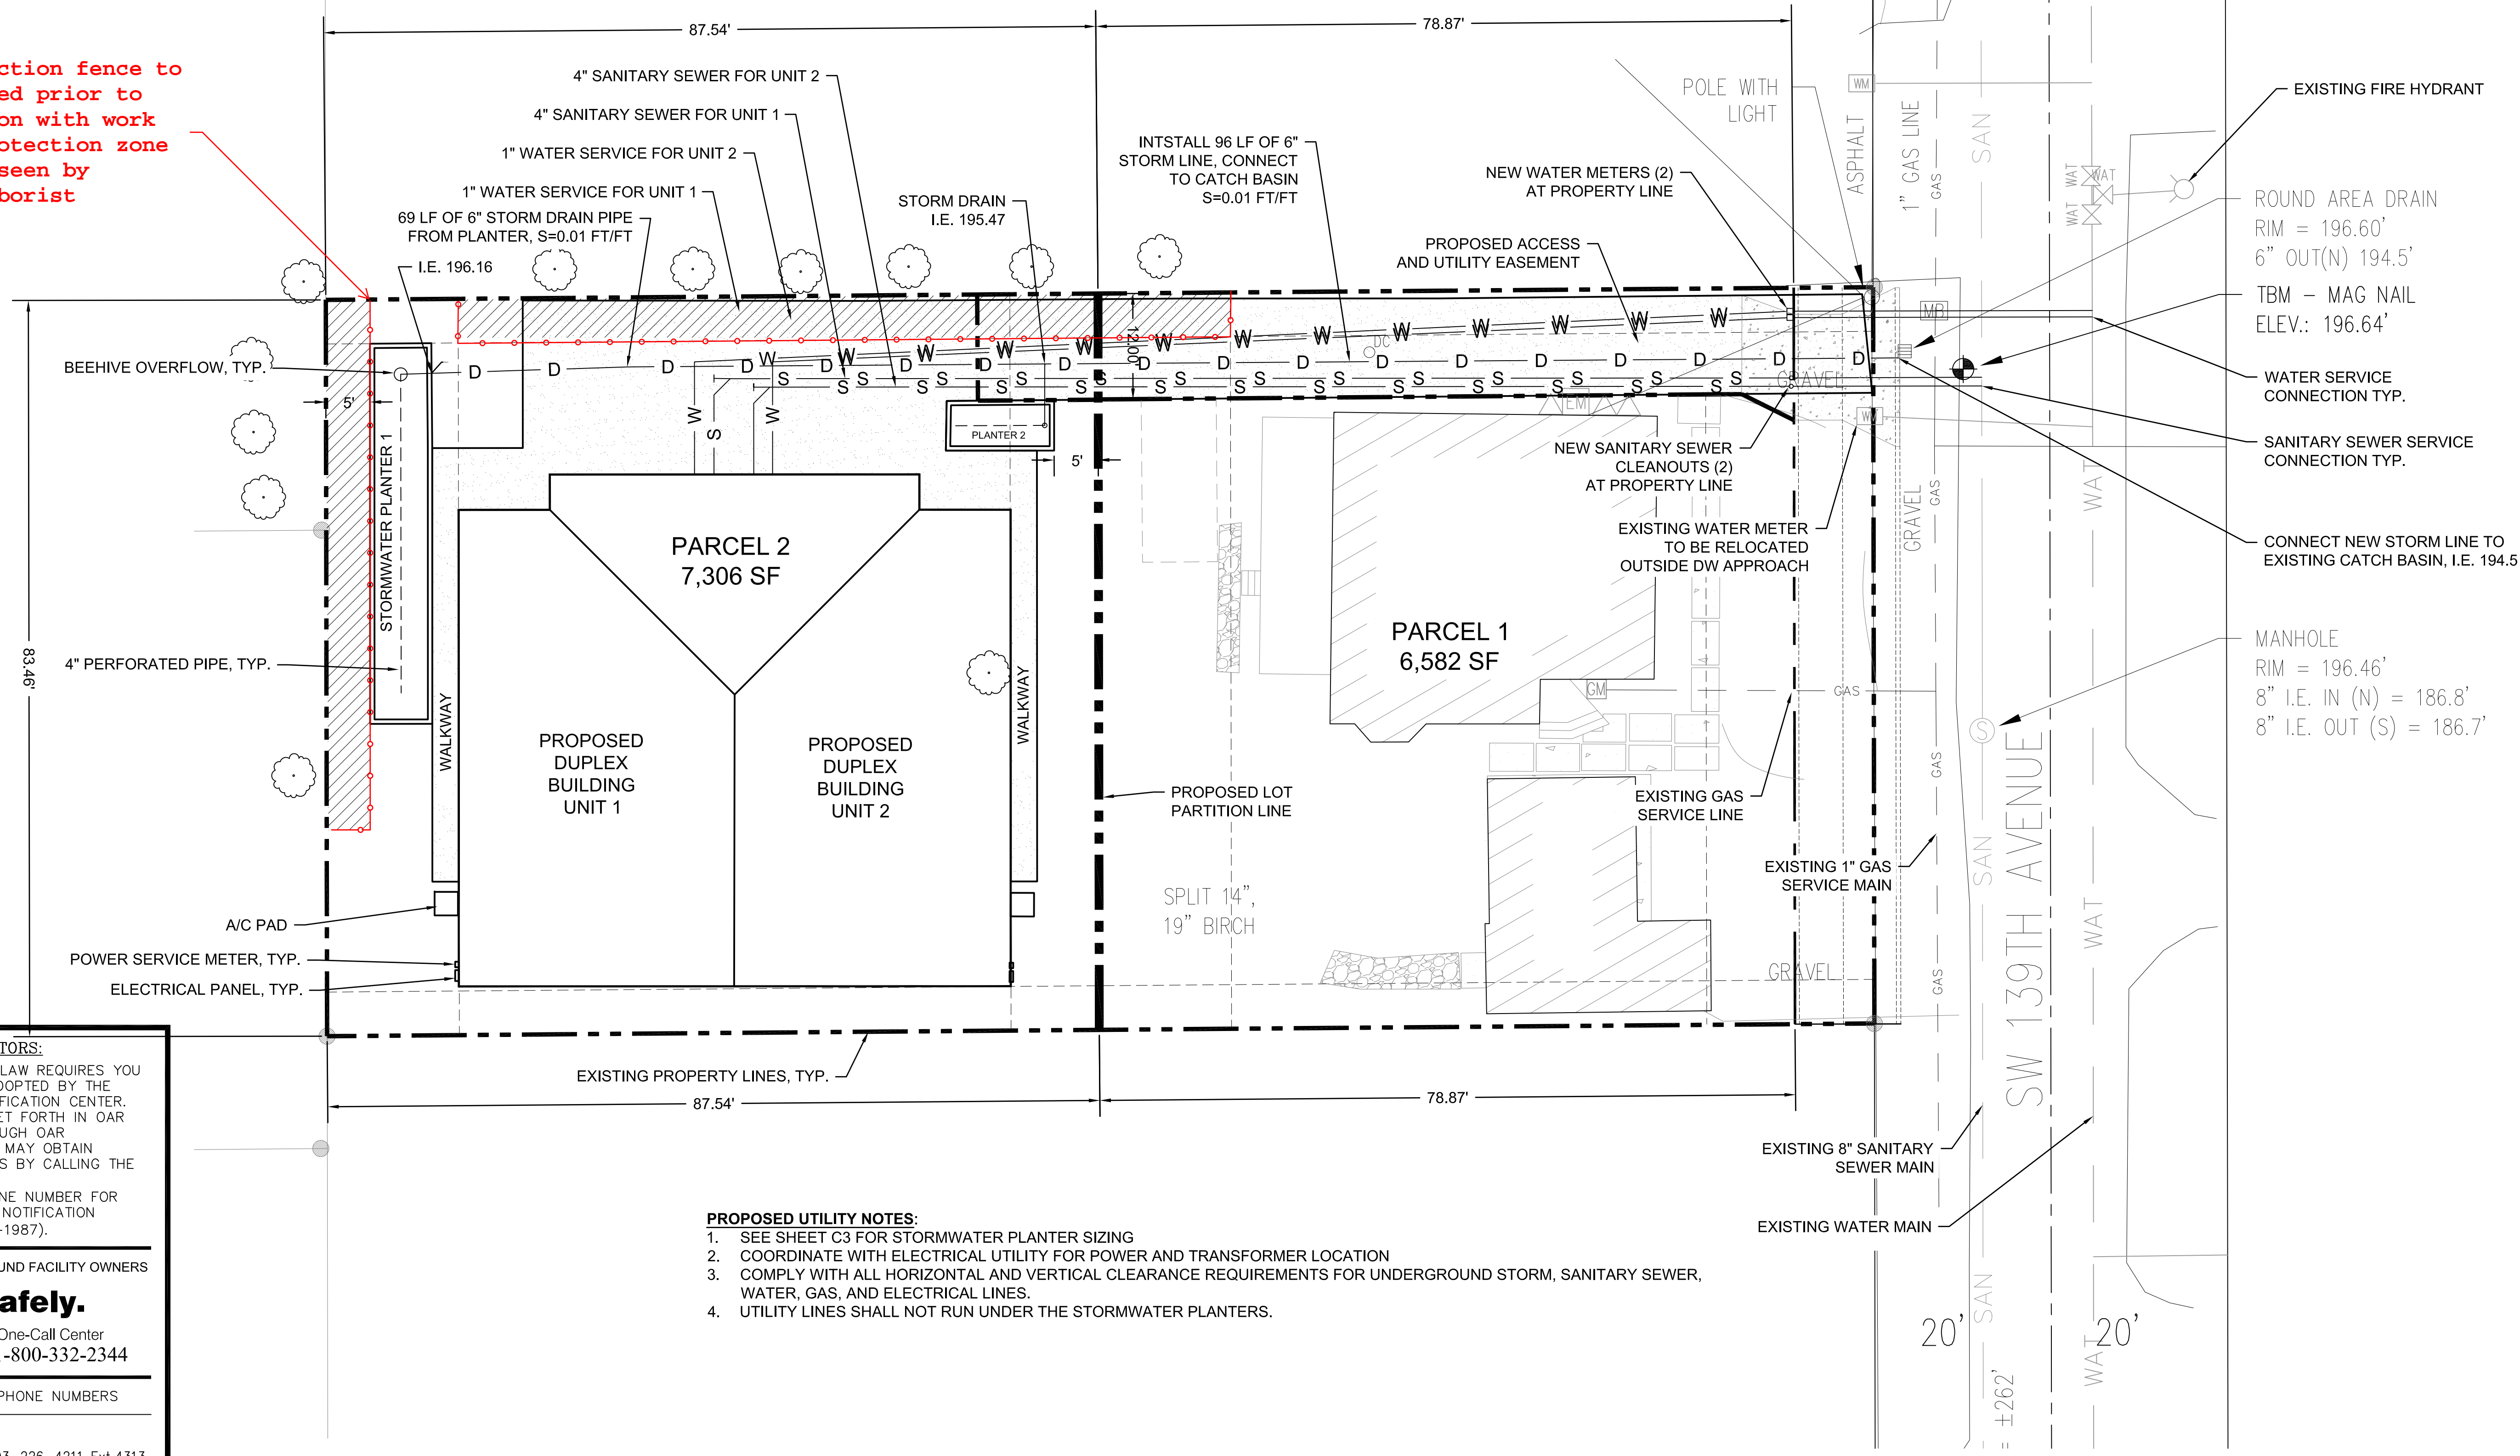

EXISTING FIRE HYDRANT
ROUND AREA DRAIN
RIM = 196.60'
6" OUT(N) 194.5'
TBM - MAG NAIL
ELEV.: 196.64'
WATER SERVICE CONNECTION TYP.
SANITARY SEWER SERVICE CONNECTION TYP.
CONNECT NEW STORM LINE TO EXISTING CATCH BASIN, I.E. 194.5
MANHOLE
RIM = 196.46'
8" I.E. IN (N) = 186.8'
8" I.E. OUT (S) = 186.7'



NOTICE TO EXCAVATORS:
ATTENTION: OREGON LAW REQUIRES YOU TO FOLLOW RULES ADOPTED BY THE OREGON UTILITY NOTIFICATION CENTER. THOSE RULES ARE SET FORTH IN OAR 952-001-0010 THROUGH OAR 952-001-0090. YOU MAY OBTAIN COPIES OF THE RULES BY CALLING THE CENTER.
(NOTE: THE TELEPHONE NUMBER FOR THE OREGON UTILITY NOTIFICATION CENTER IS 503-232-1987).

POTENTIAL UNDERGROUND FACILITY OWNERS
Dig Safely.
Call the Oregon One-Call Center
DIAL 811 or 1-800-332-2344
EMERGENCY TELEPHONE NUMBERS



- PROPOSED UTILITY NOTES:**
1. SEE SHEET C3 FOR STORMWATER PLANTER SIZING
 2. COORDINATE WITH ELECTRICAL UTILITY FOR POWER AND TRANSFORMER LOCATION
 3. COMPLY WITH ALL HORIZONTAL AND VERTICAL CLEARANCE REQUIREMENTS FOR UNDERGROUND STORM, SANITARY SEWER, WATER, GAS, AND ELECTRICAL LINES.
 4. UTILITY LINES SHALL NOT RUN UNDER THE STORMWATER PLANTERS.



UTILITY PLAN
SCALE: 1"=10'

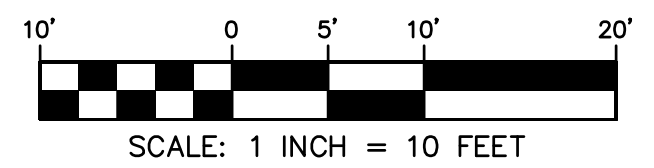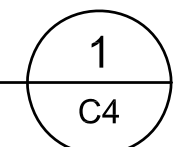

Attachment 2

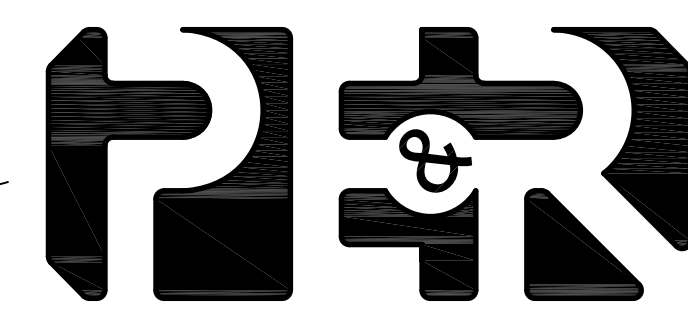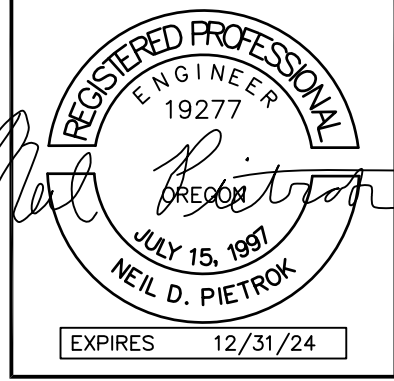

PIETROK ENGINEERING AND RESOURCES LLC
13539 NW Springville Road
Portland, OR 97229
PH: 503-793-3469

FILENAME	178-C5
DATE	06/06/2023
DESIGNER	NDP
DRAFTER	NDP
REVIEWER	DI

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R129462
ZONING: SFR, RMC


SW 139TH AVENUE

BEAVERTON, OR

LOT PARTITION PROPOSED UTILITY PLAN

No.	REVISION	DATE	BY
1		12/8/23	NDP

SHEET 5 OF 9
DRAWING NUMBER 178-C5

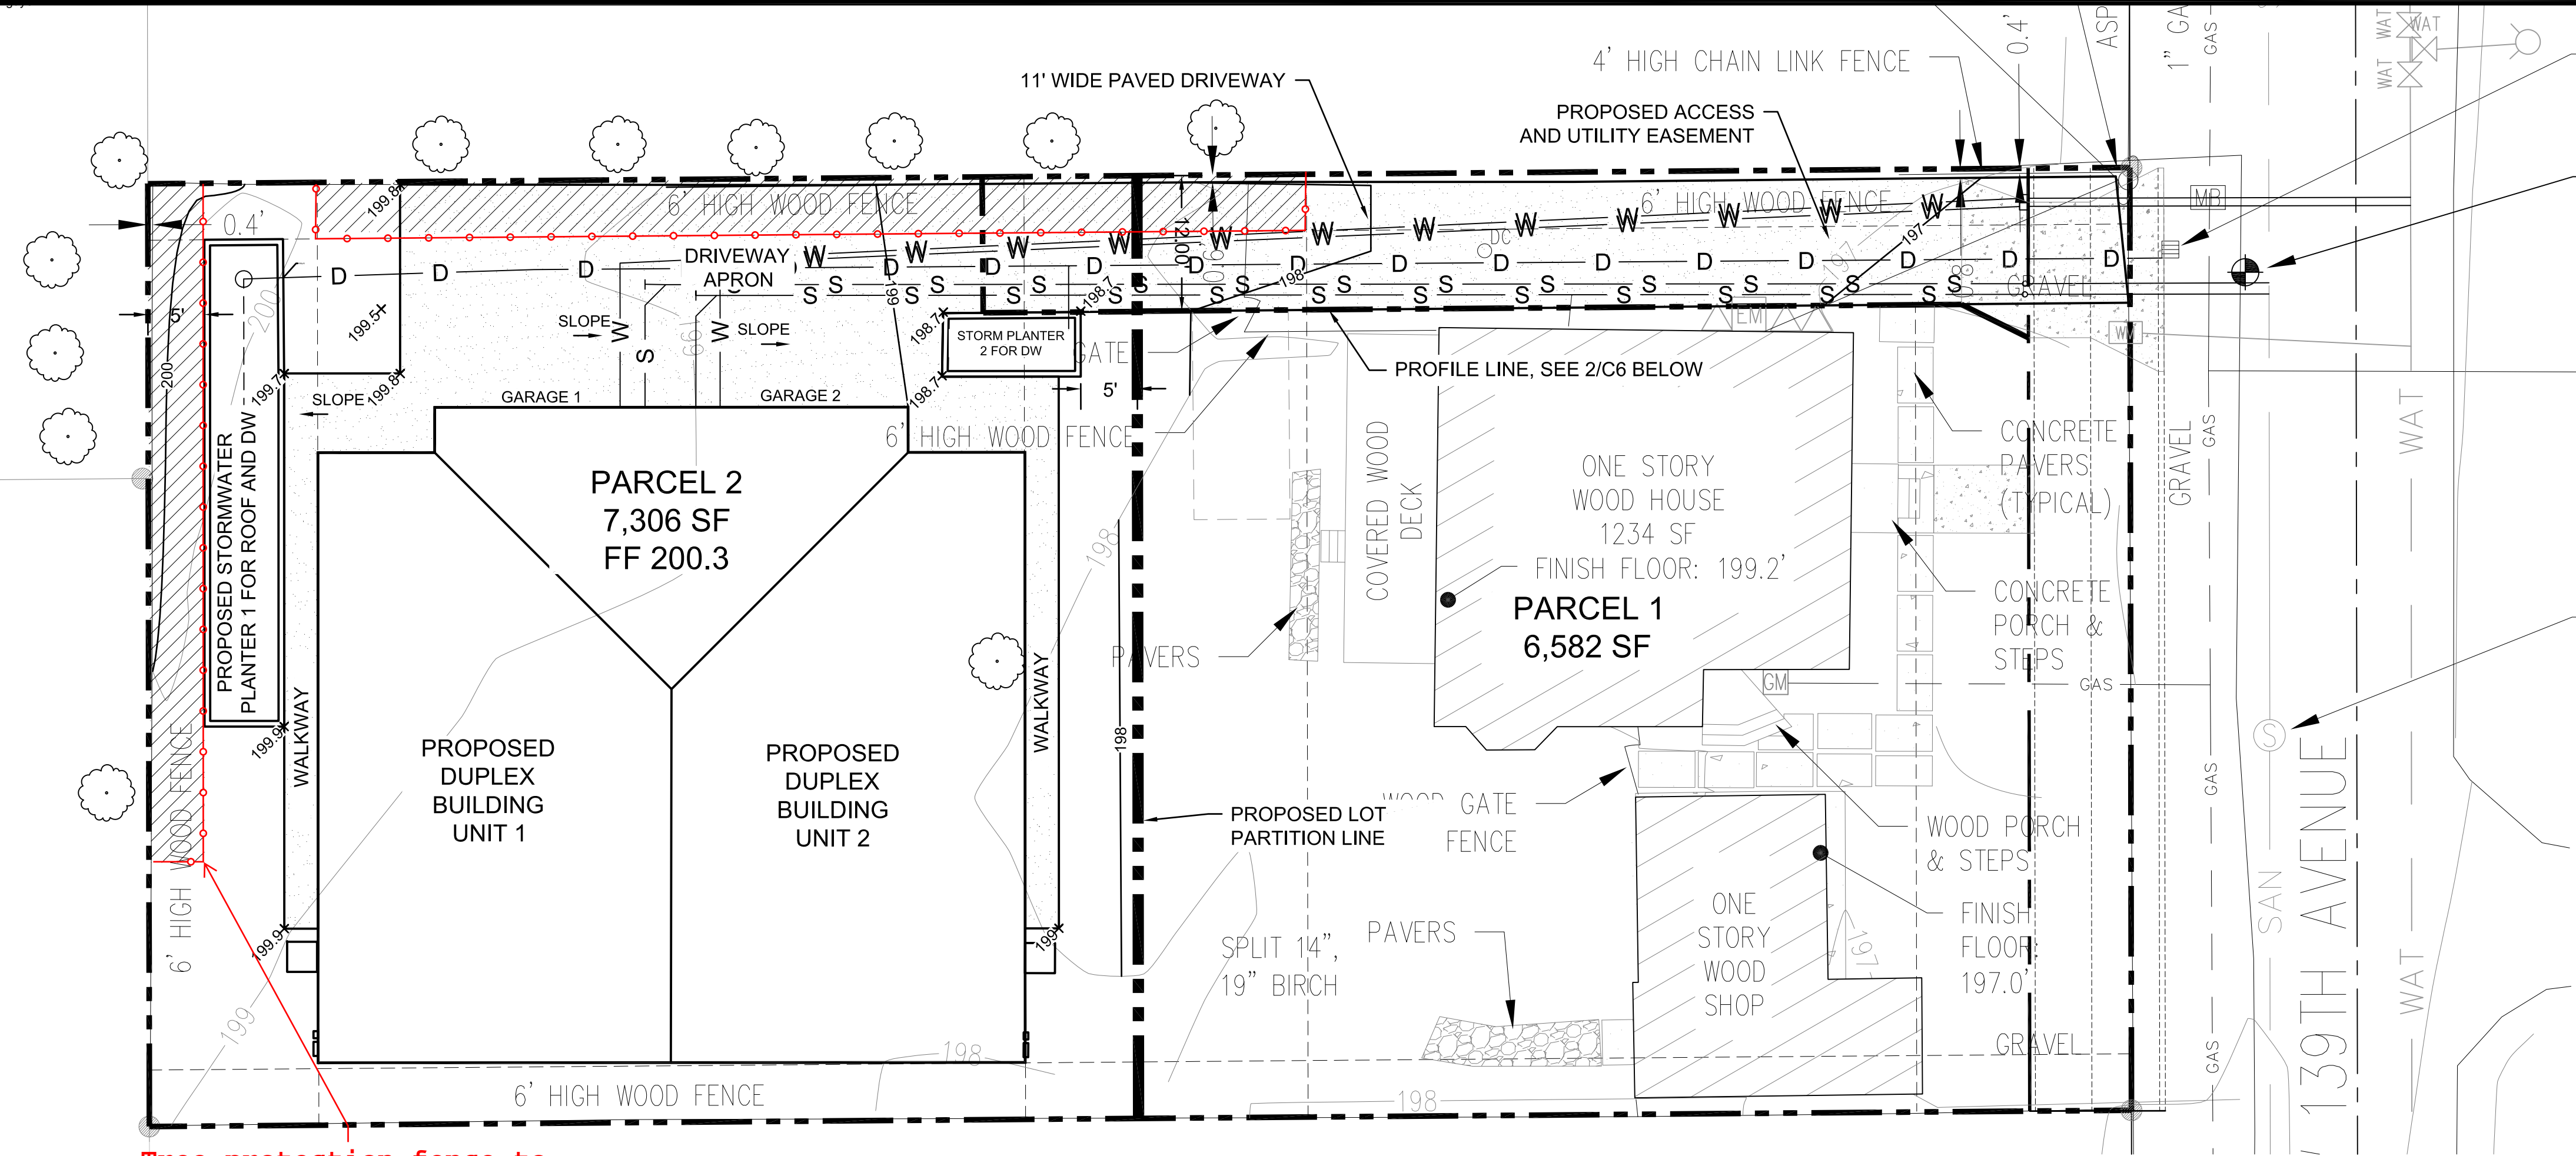




ROUND AREA DRAIN
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ELEV.: 196.64'

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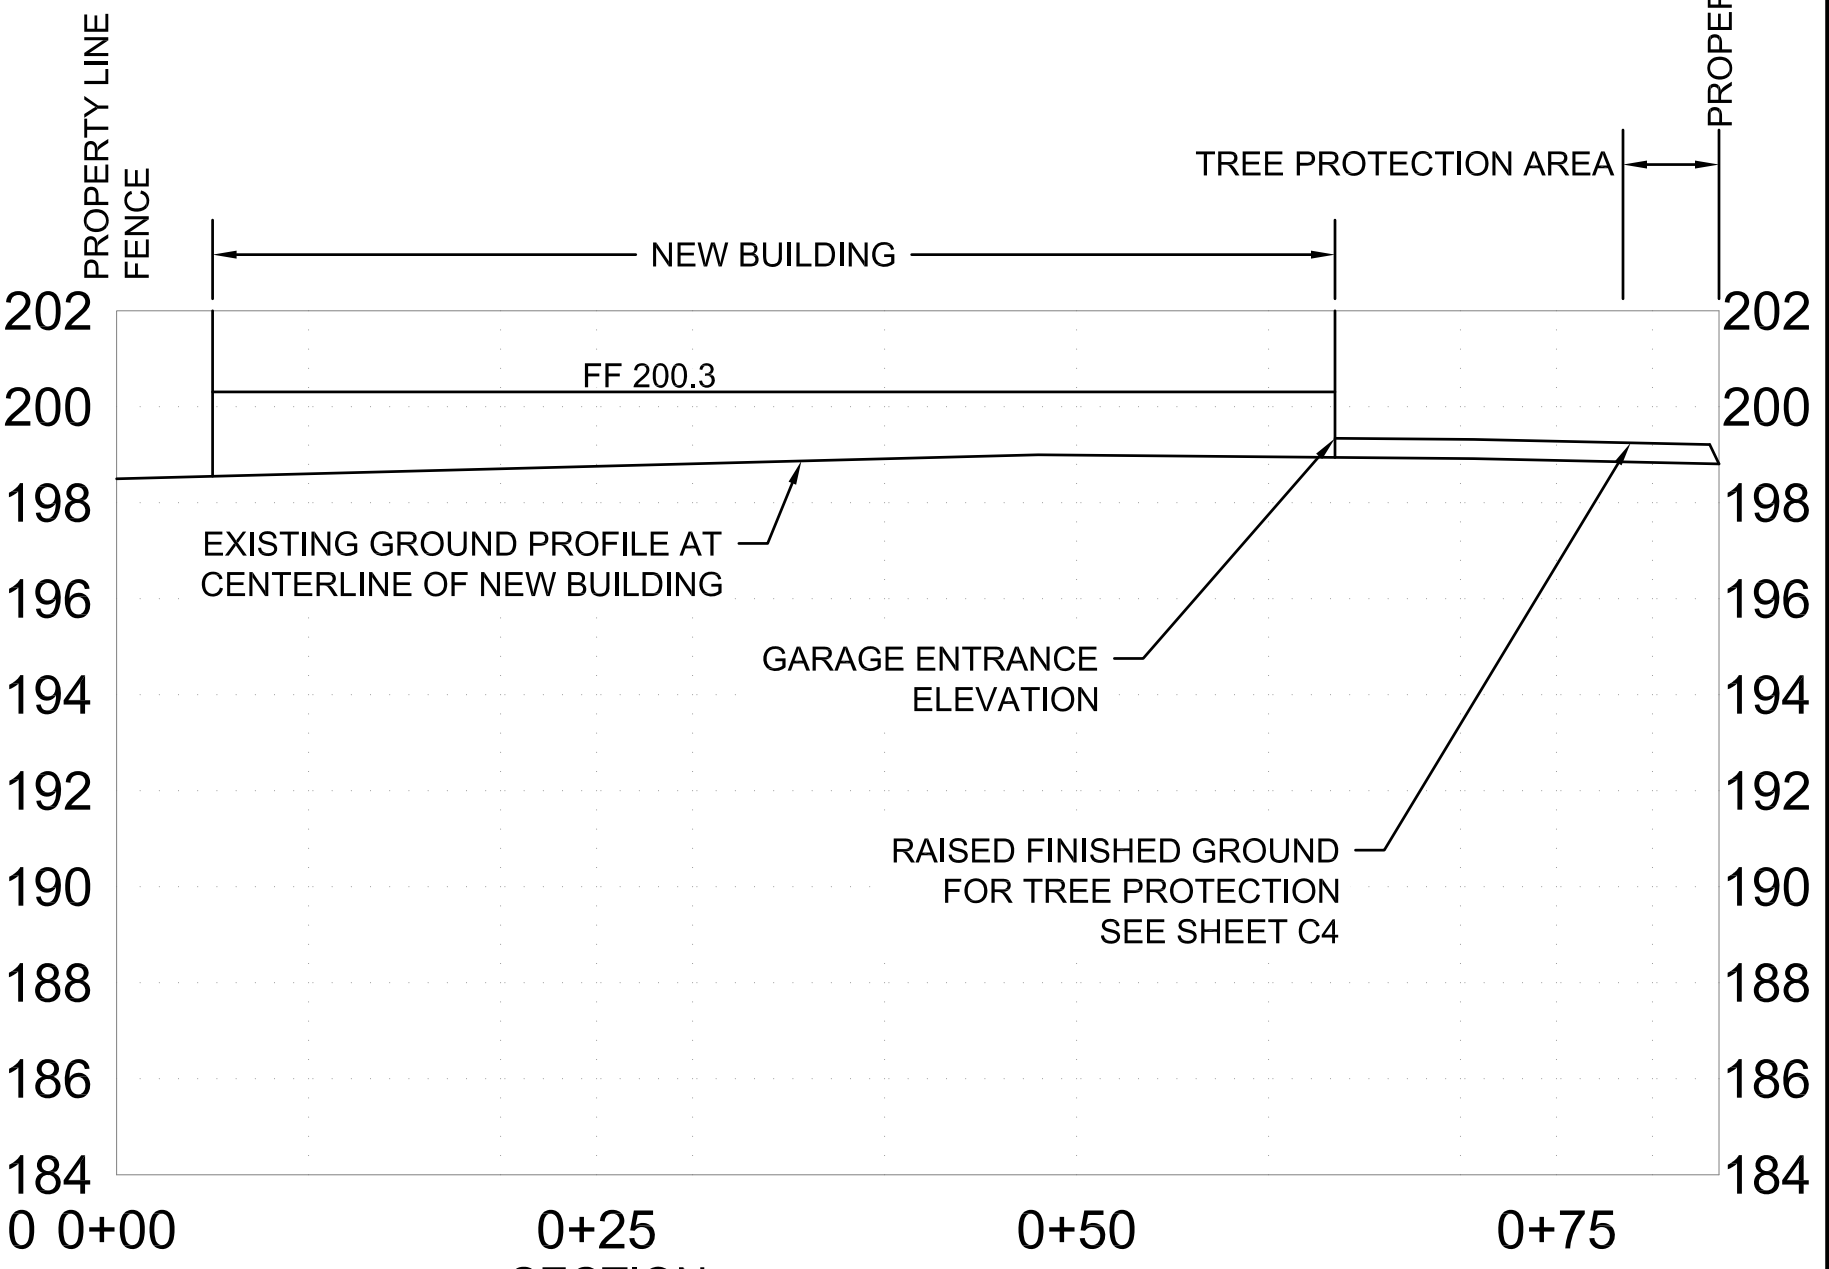
Tree protection fence to be installed prior to construction with work in tree protection zone to be overseen by project arborist



PROPOSED SITE PLAN
SCALE: 1"=10'

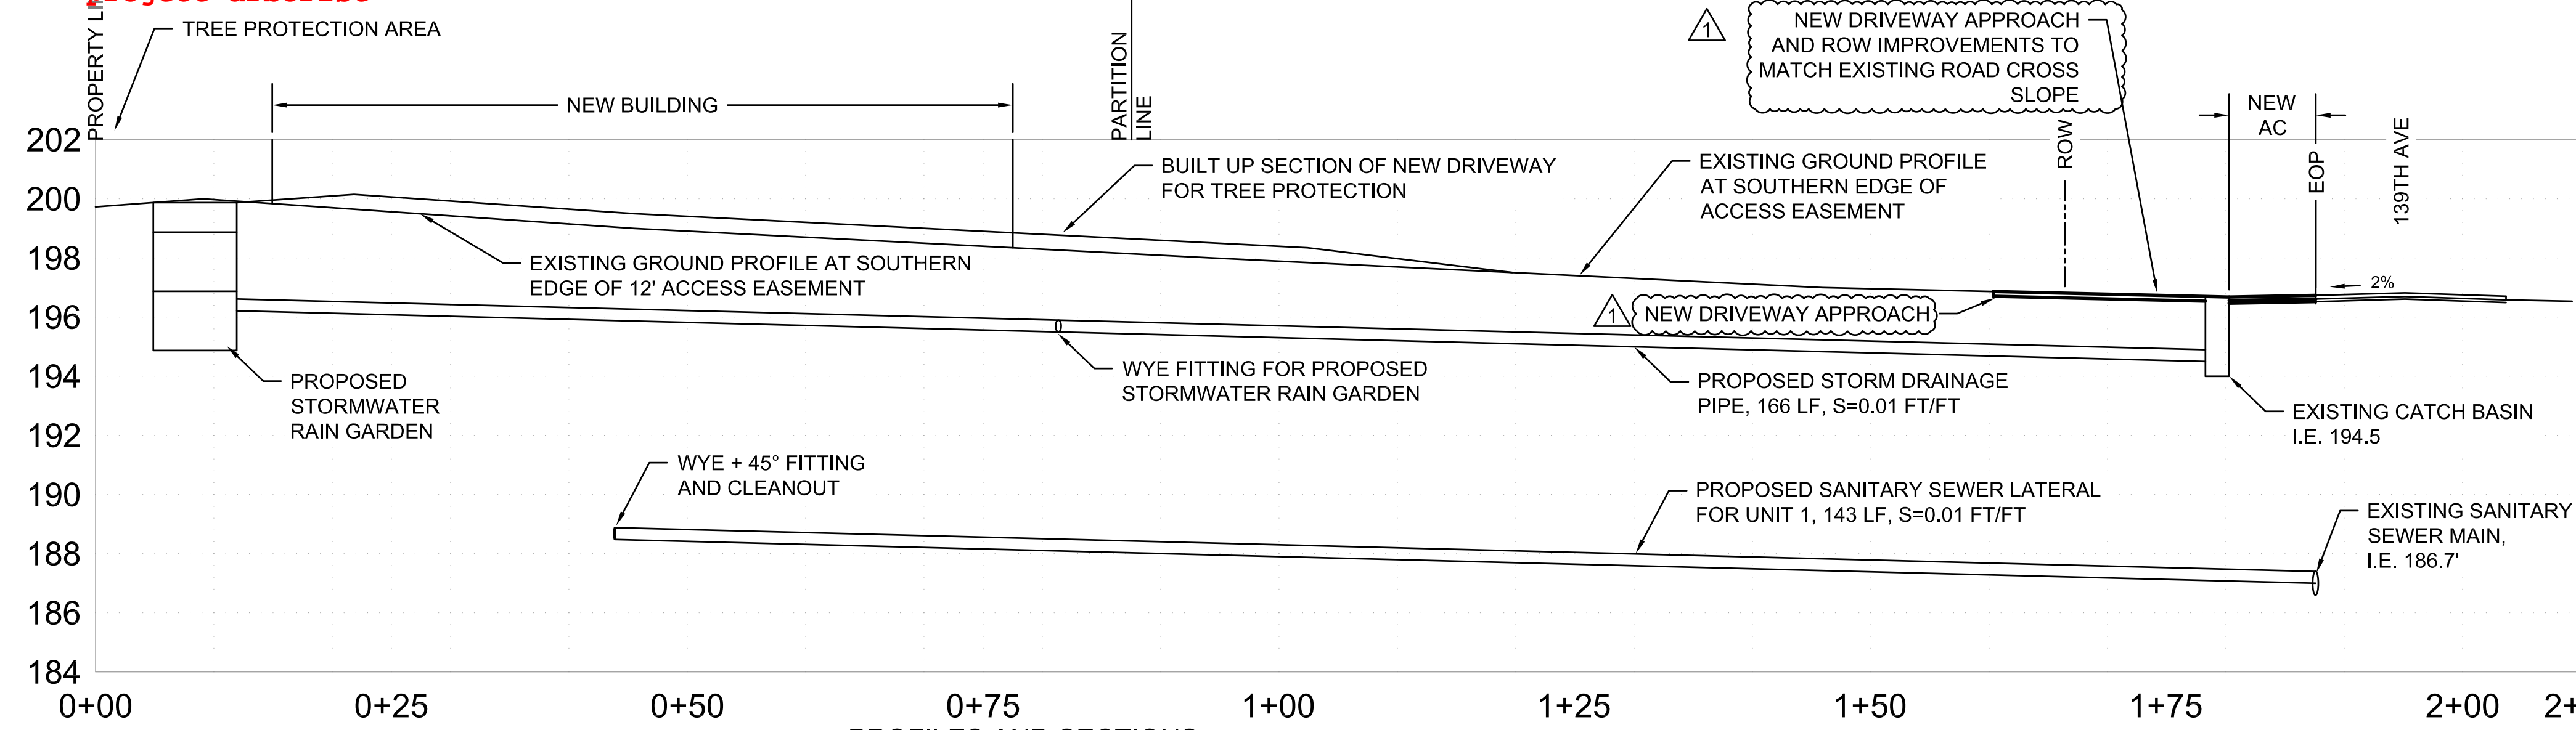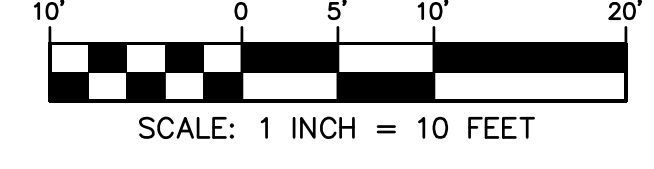
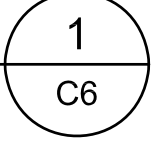


PROFILES AND SECTIONS AT SOUTHERN EDGE OF ACCESS RD
SCALE: HORIZ. 1"=10'
VERT. 1"=4'



SECTION AT CENTERLINE OF NEW BUILDING
SCALE: HORIZ. 1"=10'
VERT. 1"=4'

Attachment 2

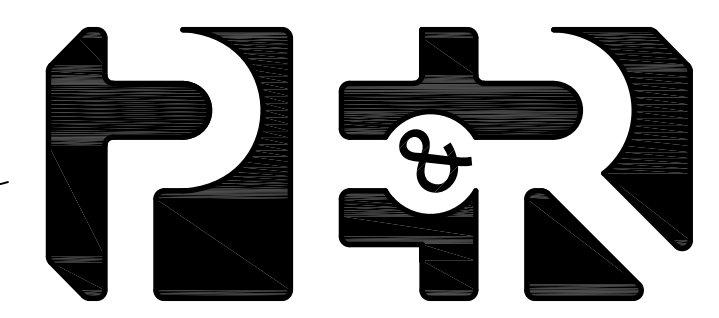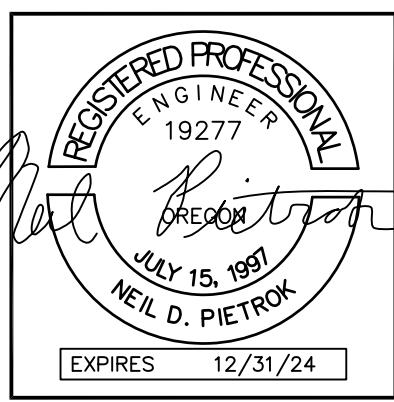

PIETROK ENGINEERING AND RESOURCES LLC
13539 NW Springville Road
Portland, OR 97229
PH: 503-793-3469

FILENAME	178-C4
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REVIEWER	DI

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R129462
ZONING: SFR, RMC


SW 139TH AVENUE

BEAVERTON, OR



**LOT PARTITION
PROFILES AND SECTIONS**

No.	REVISION	DATE	BY
1		12/8/23	NDP


SHEET 6 OF 9
DRAWING NUMBER 178-C6

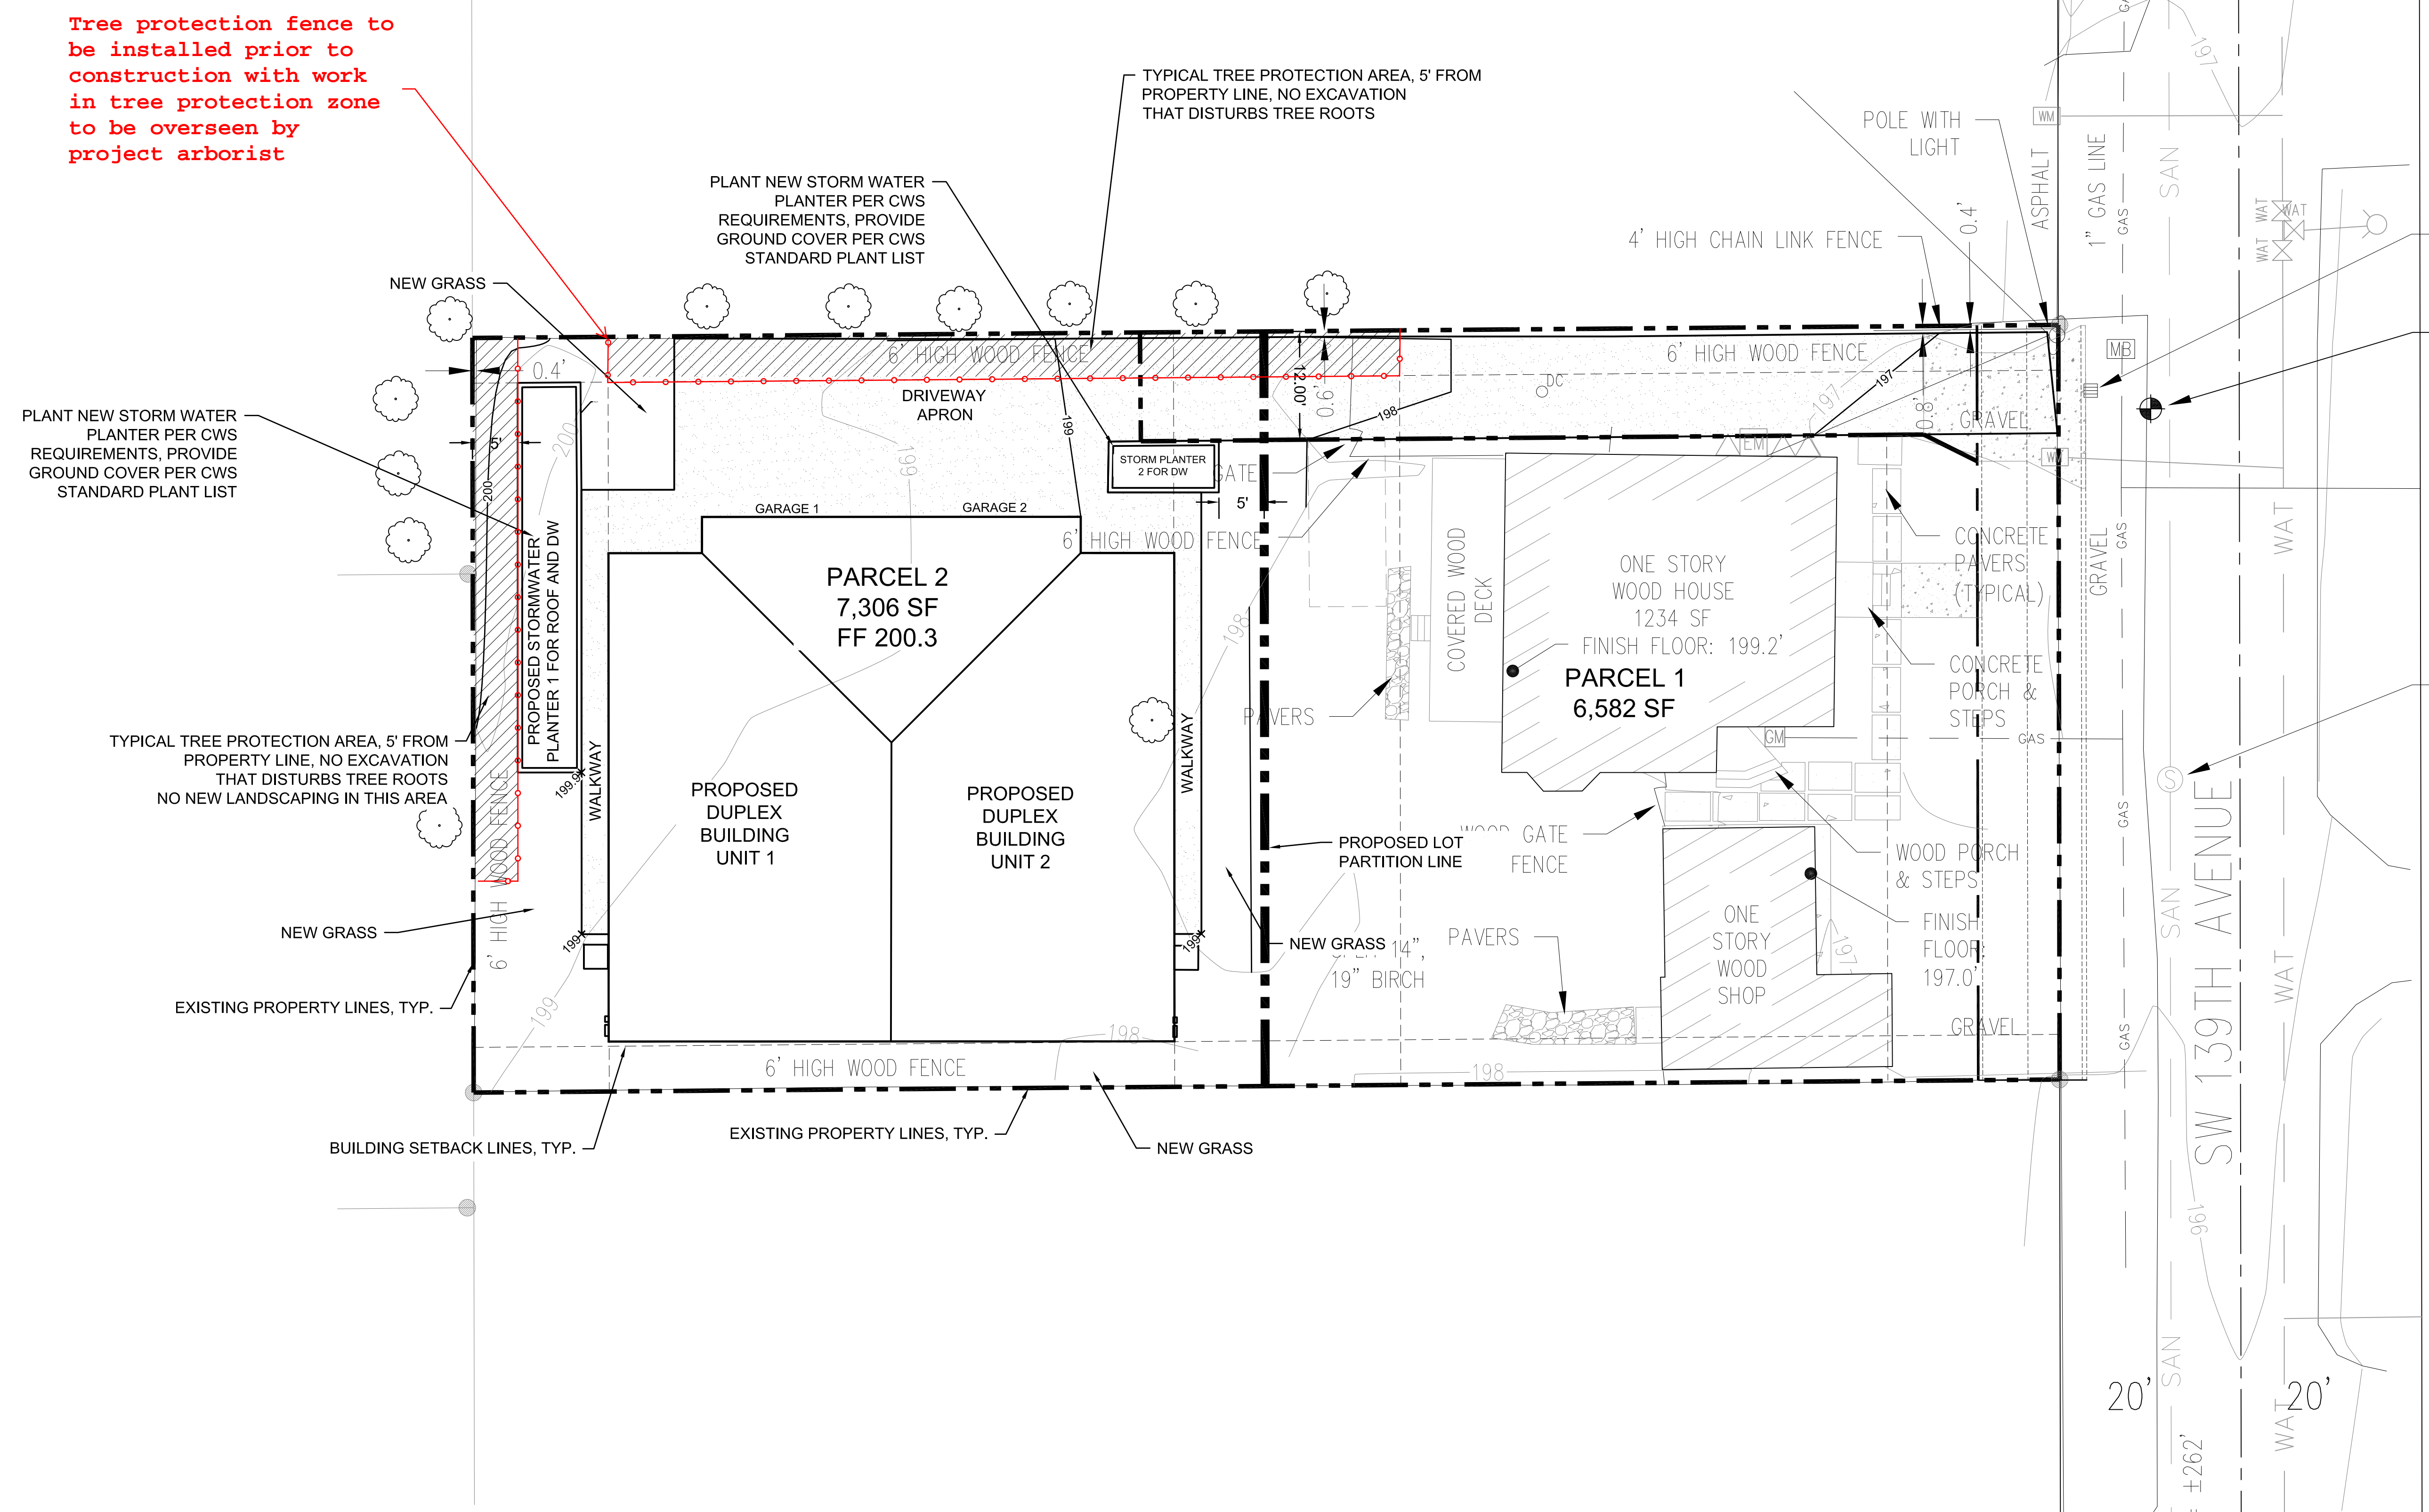

PROPOSED LANDSCAPING PLAN
SCALE: 1"=10'

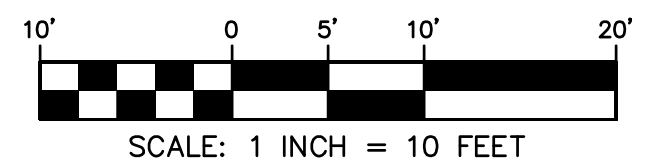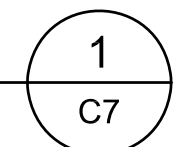

Attachment 2

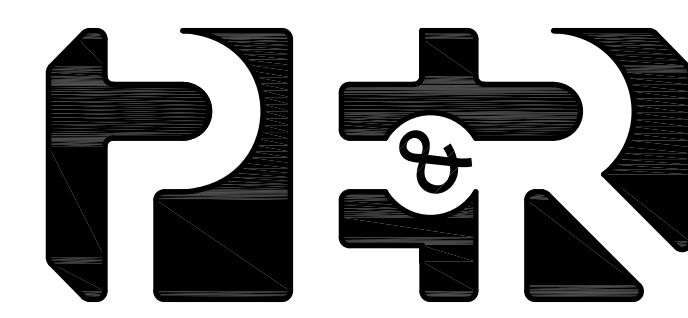 <p>PIETROK ENGINEERING AND RESOURCES LLC 13539 NW Springville Road Portland, OR 97229 PH: 503-793-3469</p>	<p>FILENAME 178-L1</p>	<p>TWO LOT PARTITION FOR TL ID: 1S116CA03000 4975 SW 139TH AVENUE BEAVERTON, OREGON 97005 R129462 ZONING: SFR, RMC</p>	<p>SW 139TH AVENUE</p> <p>LOT PARTITION LANDSCAPING PLAN</p> <p>BEAVERTON, OR</p>	<table border="1"> <tr> <td>1</td> <td>REVISION</td> <td>12/8/23</td> <td>NDP</td> </tr> <tr> <td> </td> <td> </td> <td> </td> <td> </td> </tr> <tr> <td> </td> <td> </td> <td> </td> <td> </td> </tr> <tr> <td> </td> <td> </td> <td> </td> <td> </td> </tr> <tr> <td> </td> <td> </td> <td> </td> <td> </td> </tr> <tr> <td>No.</td> <td>REVISION</td> <td>DATE</td> <td>BY</td> </tr> </table>	1	REVISION	12/8/23	NDP																	No.	REVISION	DATE	BY	<p>SHEET 9 OF 7 DRAWING NUMBER 178-L1</p>
	1	REVISION	12/8/23	NDP																									
No.	REVISION	DATE	BY																										
<p>FILENAME 178-L1</p> <p>DATE 12/3/2023</p> <p>DESIGNER NDP</p> <p>DRAFTER NDP</p> <p>REVIEWER DI</p>	<p>SW 139TH AVENUE</p> <p>BEAVERTON, OR</p>	<p>1</p>	REVISION	12/8/23	NDP																								



Tree No.	Common Name	Scientific Name	Decid. or Conf.	DBH ¹	C-Rad ²	Condition ³	Structure ³	Comments	Tree Type	Treatment
①	orchard apple	<i>Malus domestica</i>	decid.	15	13	fair	fair	headed for fruit production	exempt ⁴ (edible fruit tree)	remove
②	western redcedar	<i>Thuja plicata</i>	conf.	10	11	very poor	very poor	dying from top down	community tree	remove
③	incense cedar	<i>Calocedrus decurrens</i>	conf.	12,12	10	fair	fair	headed, offsite, size and location approximated by arborist	offsite	retain
④	incense cedar	<i>Calocedrus decurrens</i>	conf.	7	5	good	fair	moderately one sided, offsite, size and location approximated by arborist	offsite	retain
⑤	incense cedar	<i>Calocedrus decurrens</i>	conf.	7	4	good	good	offsite, size and location approximated by arborist	offsite	retain
⑥	incense cedar	<i>Calocedrus decurrens</i>	conf.	14	8	fair	fair	headed, one sided, offsite, size and location approximated by arborist	offsite	retain
⑦	incense cedar	<i>Calocedrus decurrens</i>	conf.	8	6	good	fair	multiple leaders at top, offsite, size and location approximated by arborist	offsite	retain
⑧	incense cedar	<i>Calocedrus decurrens</i>	conf.	12	4	fair	fair	headed, one sided, offsite, size and location approximated by arborist	offsite	retain
⑨	incense cedar	<i>Calocedrus decurrens</i>	conf.	14	10	good	fair	codominant at 8', one sided, offsite, size and location approximated by arborist	offsite	retain
⑩	incense cedar	<i>Calocedrus decurrens</i>	conf.	14	10	good	fair	codominant at 8', one sided, offsite, size and location approximated by arborist	offsite	retain
⑪	river birch	<i>Betula nigra</i>	decid.	12	20	good	fair	multiple leaders at 10' to 15', offsite, size and location approximated by arborist	offsite	retain
⑫	river birch	<i>Betula nigra</i>	decid.	13	15	good	fair	multiple leaders at 10' to 15', offsite, size and location approximated by arborist	offsite	retain
⑬	English hawthorn	<i>Crataegus monogyna</i>	decid.	7.4,3x8	8	good	fair	multiple leaders at ground level, offsite, size and location approximated by arborist	offsite	retain

¹DBH is the trunk diameter measured according to the International Society of Arboriculture standards in inches. In cases where the tree splits into multiple trunks at ground level, DBH is the square root of the sum of the squared DBH of each stem.

²C-rad is the approximate crown radius in feet.

³Condition and Structure ratings range from very poor, poor, fair, to good.


⁴Exempt trees include hemlock, madrone, and bigleaf maples less than 6-inch DBH, any other species less than 10-inch DBH, trees listed as a nuisance species on the Metro Native Plant List (Ord. No. 98-730C) or Beaverton Development Code Section 40.90.10, trees producing edible fruits, offsite trees, and stumps. Note that although hemlock, madrone, and bigleaf maples between 6- and 10-inch DBH are surveyed trees, they are not considered community trees and thus are "exempt".

Todd Prager Associates, LLC
601 Atwater Road • Lake Oswego, OR 97034
Phone: 971.295.4835 • Email: todd@todprager.com • Website: todprager.com

LEGEND

- DECIDUOUS TREE
- CONIFEROUS TREE
- FIRE HYDRANT
- WATER METER
- WATER VALVE
- SANITARY SEWER MANHOLE
- STORM SEWER CLEAN OUT
- STORM SEWER AREA DRAIN
- STORM SEWER MANHOLE
- GAS METER
- UTILITY POLE
- ELECTRICAL METER
- TELEPHONE/TELEVISION JUNCTION BOX
- MAILBOX
- FOUND SURVEY MONUMENT

- RIGHT-OF-WAY LINE
- PROPERTY LINE
- CENTERLINE
- EDGE OF PAVEMENT
- FENCE LINE
- GRAVEL EDGE
- OVERHEAD WIRE
- GAS LINE
- STORM SEWER LINE
- SANITARY SEWER LINE
- WATER LINE

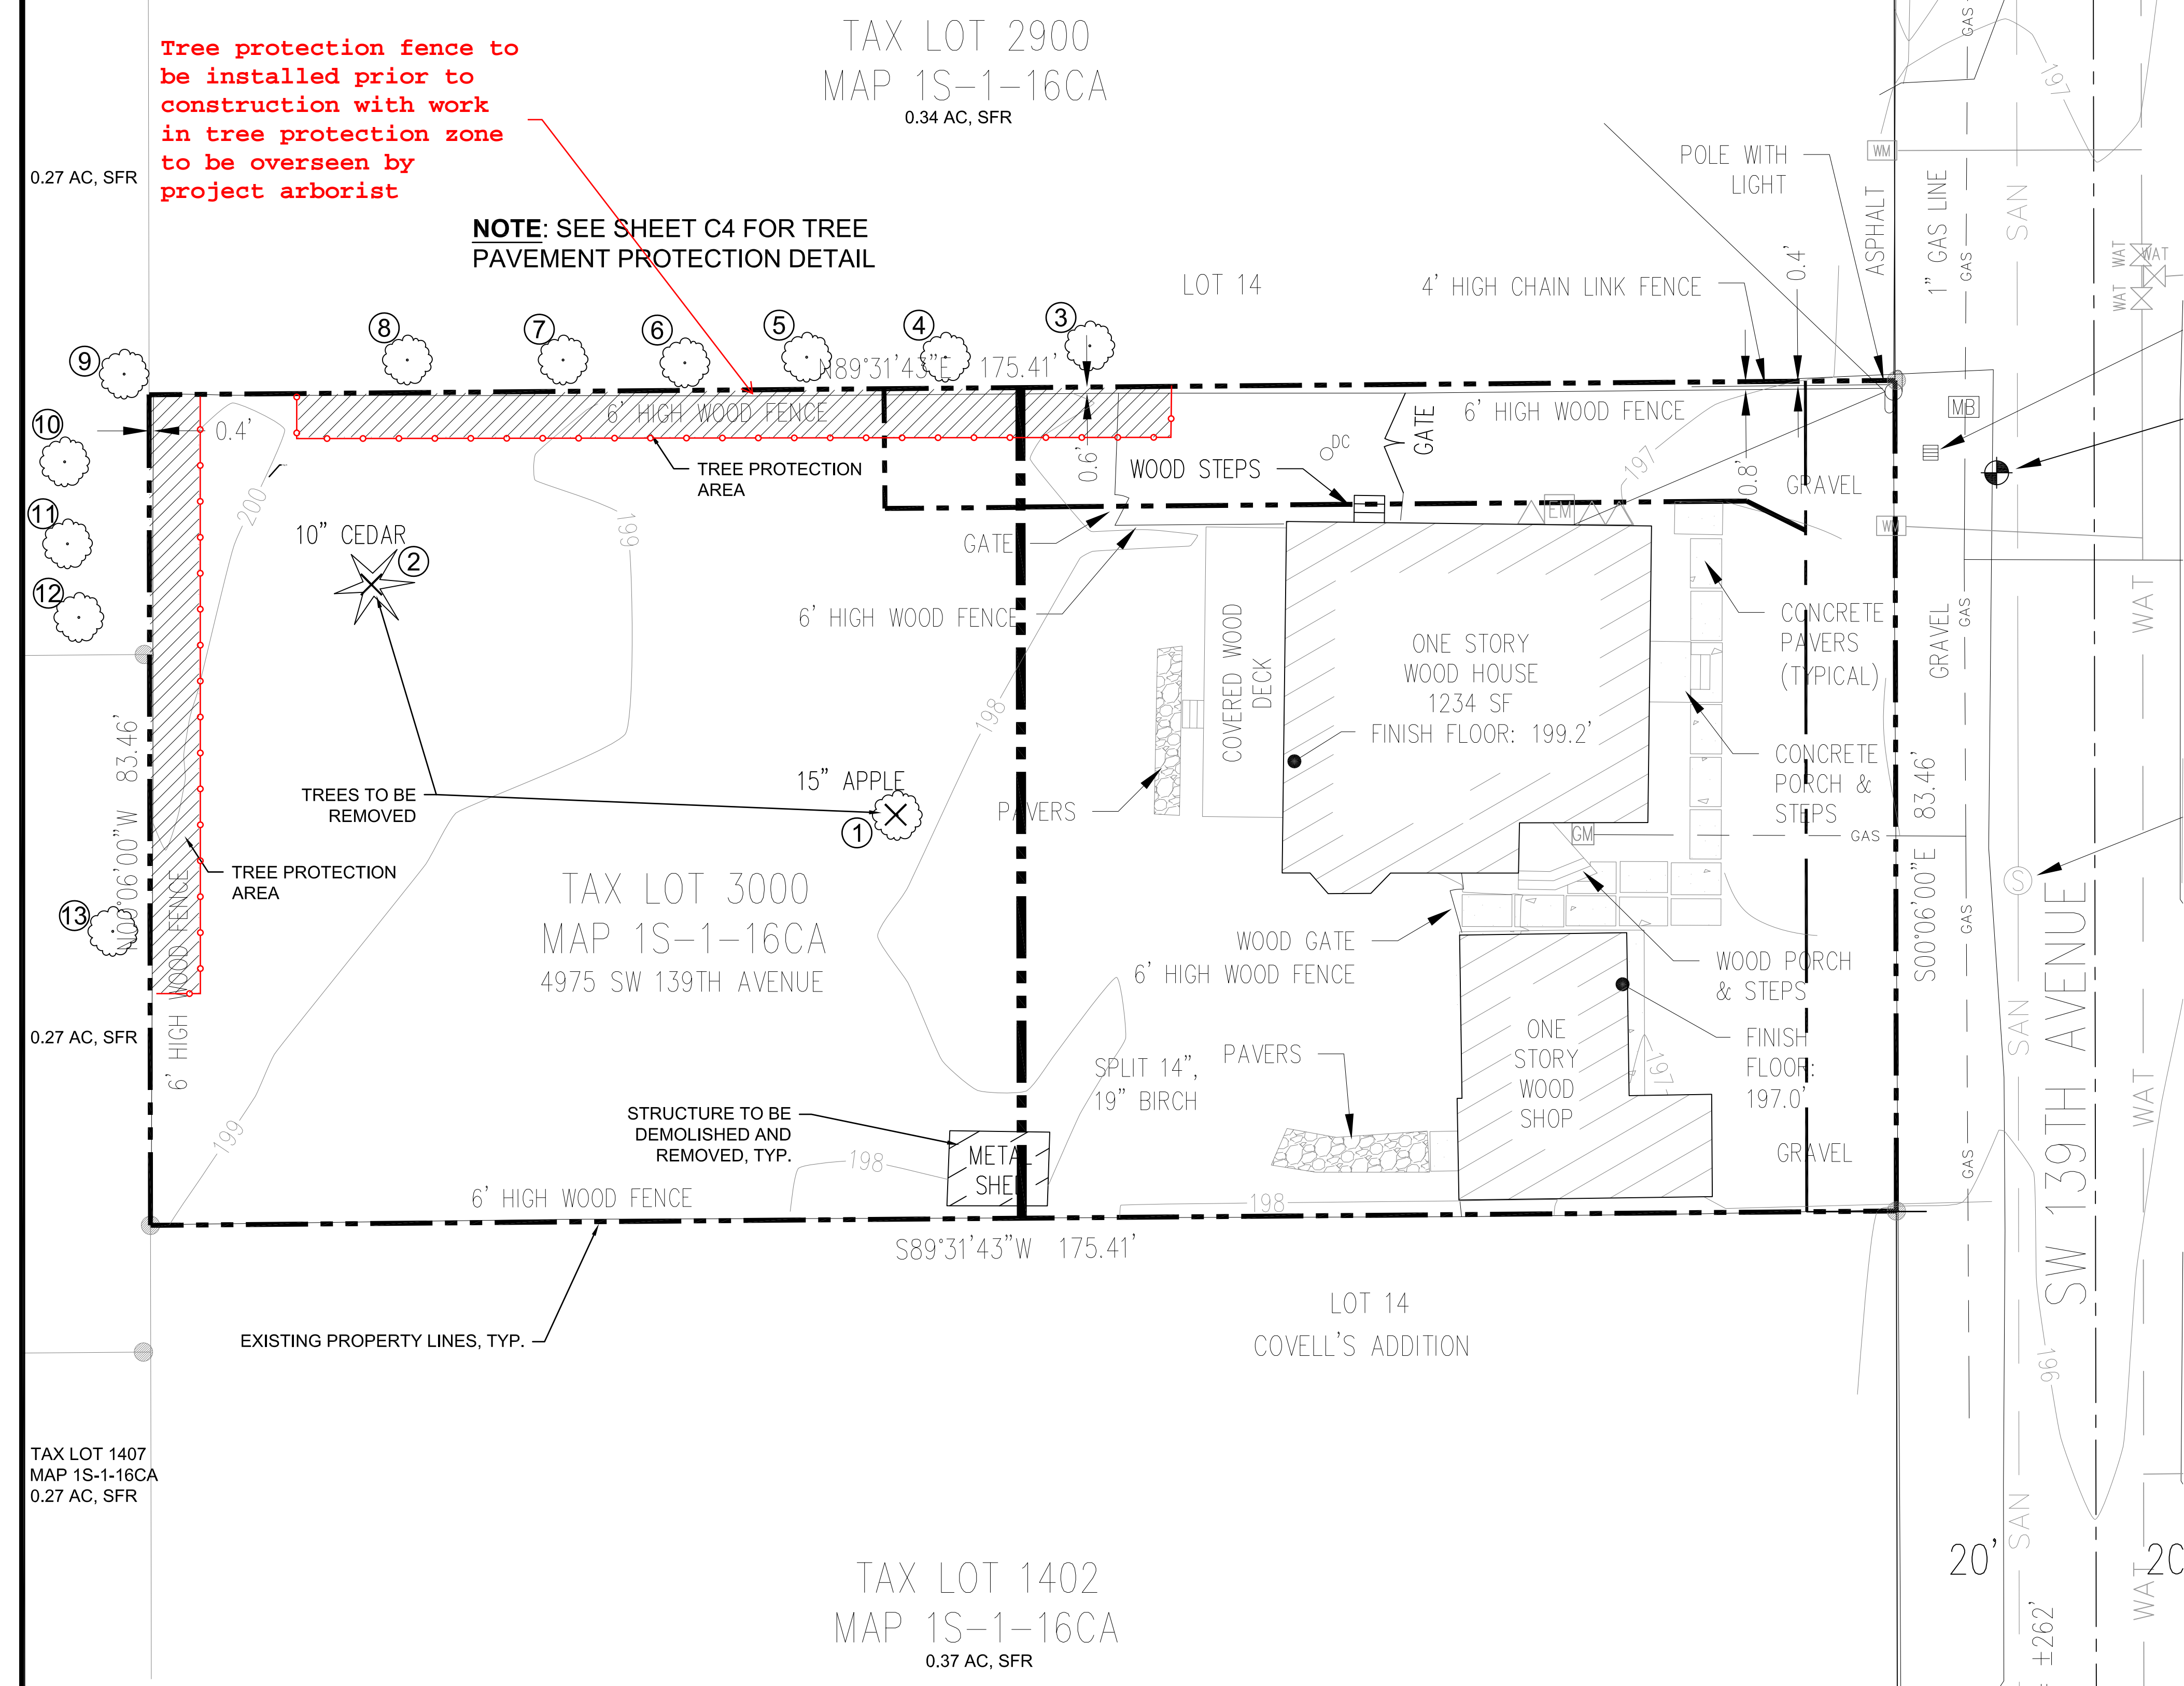

Tree protection fence to be installed prior to construction with work in tree protection zone to be overseen by project arborist

NOTE: SEE SHEET C4 FOR TREE PAVEMENT PROTECTION DETAIL

TREE PLAN
TREE PLAN
SCALE: 1"=10'



Attachment 2

FILENAME 178-T1 DATE 11/24/2023 DESIGNER TPA DRAFTER NDP REVIEWER DI	TWO LOT PARTITION FOR TL ID: 1S116CA03000 4975 SW 139TH AVENUE BEAVERTON, OREGON 97005 R129462 ZONING: SFR, RMC	SW 139TH AVENUE LOT PARTITION TREE PLAN	BEAVERTON, OR	1	REVISION	12/8/23	NDP	SHEET OF 9 DRAWING NUMBER 178-T1
				No.	REVISION	DATE	BY	

Attachment 3

Assumptions and Limiting Conditions

1. Any legal description provided to the consultant is assumed to be correct. The information provided by Kim-Hien Nguyen and her consultants was the basis of the information provided in this report.
2. It is assumed that this property is not in violation of any codes, statutes, ordinances, or other governmental regulations.
3. The consultant is not responsible for information gathered from others involved in various activities pertaining to this project. Care has been taken to obtain information from reliable sources.
4. Loss or alteration of any part of this delivered report invalidates the entire report.
5. Drawings and information contained in this report may not be to scale and are intended to be used as display points of reference only.
6. The consultant's role is only to make recommendations. Inaction on the part of those receiving the report is not the responsibility of the consultant.
7. The purpose of this report is to provide protection recommendations for the offsite trees to be retained.